


ADMINISTRATION BUILDING
ROOFING IMPROVEMENTS

SALT LAKE COMMUNITY COLLEGE
4600 SOUTH REDWOOD ROAD
TAYLORSVILLE, UTAH

DFCM PROJECT NO. 07023660

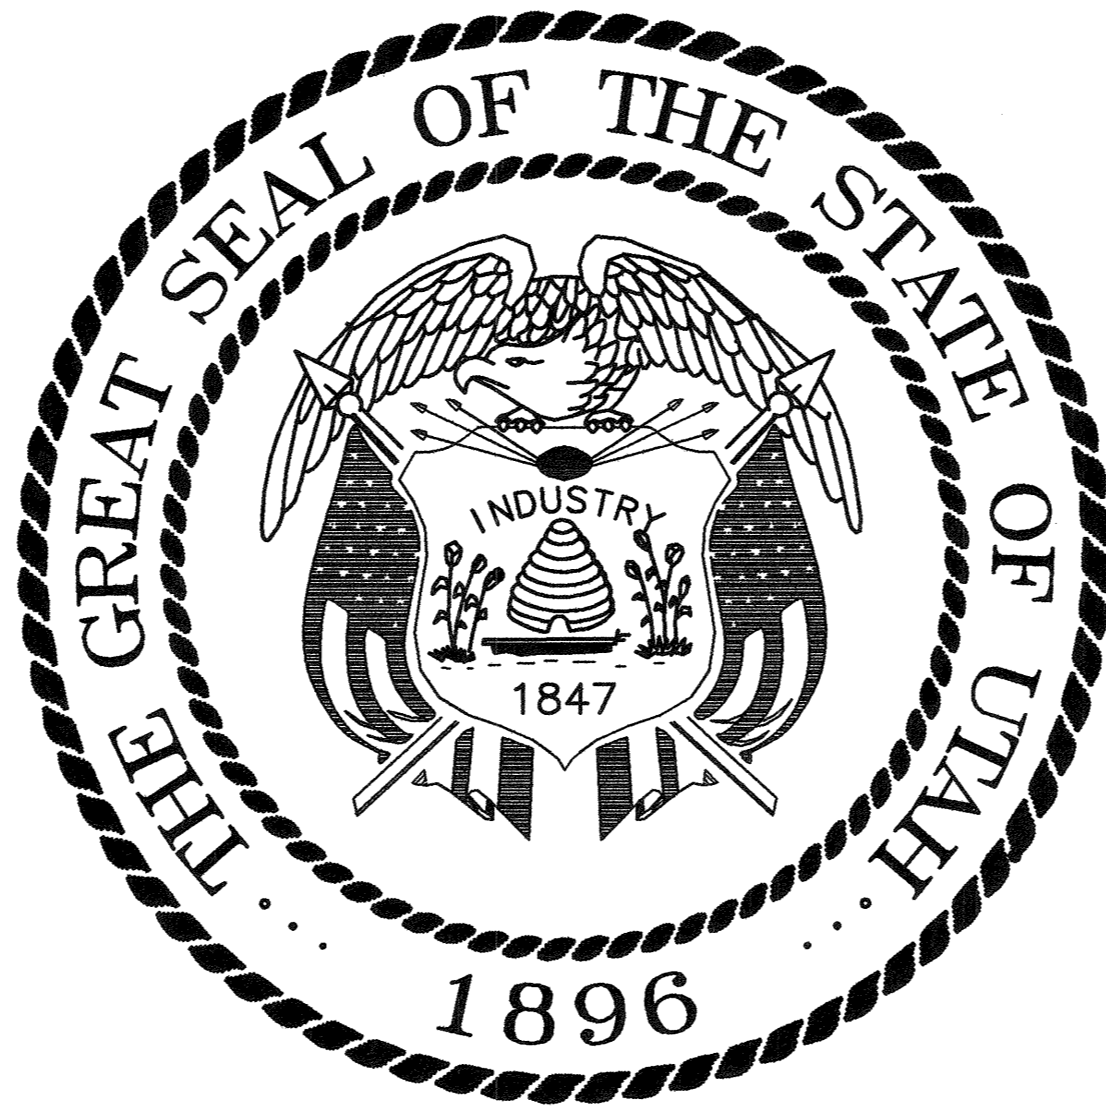

State of Utah— Department of Administrative Services


**DIVISION OF FACILITIES CONSTRUCTION
AND MANAGEMENT**

4110 State Office Building / Salt Lake City, Utah 84114 / 538-3018

May 07th, 2007

State of Utah

Department of Administrative Services

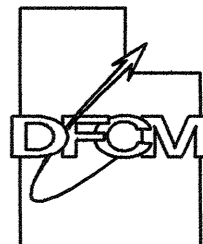



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BUILDING NAME:

SALT LAKE
COMMUNITY COLLEGE

4600 SOUTH
REDWOOD ROAD
TAYLORSVILLE, UTAH

ADMINISTRATION BUILDING

PROJECT TITLE:

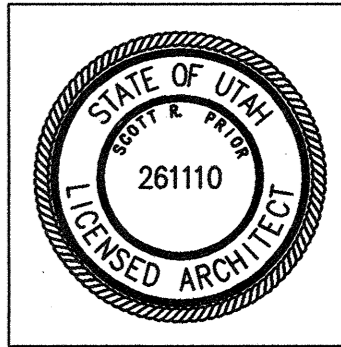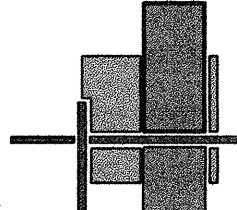SALT LAKE
COMMUNITY COLLEGE
REDWOOD ROAD CAMPUS
ADMINISTRATION BUILDING
ROOFING IMPROVEMENTS

MARK	DATE	DESCRIPTION
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ISSUE TYPE: CONSTRUCTION DOCUMENTS

ISSUE DATE: 07th May, 2007

DFCM PROJECT NO: 07023660

CAD PROJECT NO:

CAD DWG FILE:

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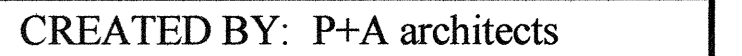
COVER SHEET

SHEET NUMBER

A-G1000

SHEET 1 OF 9

SALT LAKE COMMUNITY COLLEGE
4600 SOUTH REDWOOD ROAD
TAYLORSVILLE, UTAH
DFCM PROJECT NO. 07023660

Internet: <http://www.dfcm.state.ut.us>

STATE OF UTAH
DEPT. OF PUBLIC SAFETY
261110
LICENSED ARCHITECT

BUILDING NAME:

ADMINISTRATION BUILDING

ISSUE TYPE: CONSTRUCTION DOCUMENTS

SHEET TITLE

INDEX SHEET

SHEET NUMBER

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A-G1001

A-G 1001

SHEET 2 OF 9

SHEET 2 OF 3

NOT TO SCALE

g) Fire Stopping, Including Tested Design Number. **5**


100



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ADMINISTRATION BUILDING

PROJECT TITLE:

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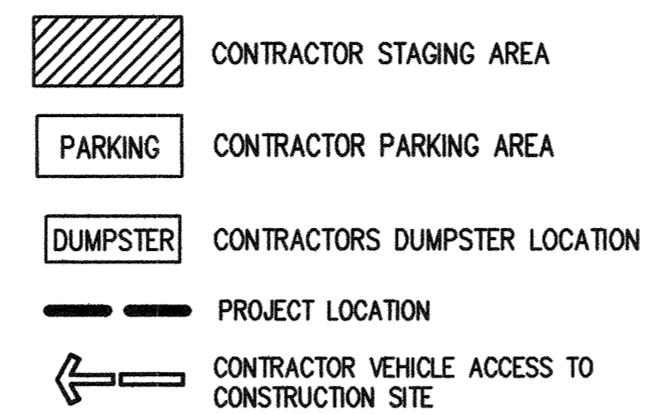
SITE PLAN

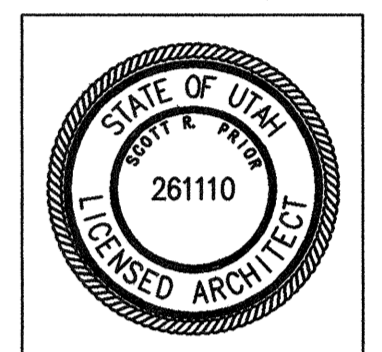SHEET NUMBER

A-SP100

SHEET 3 OF 9

LEGEND




GENERAL NOTES


1. GENERAL CONTRACTOR IS RESPONSIBLE FOR REPLACEMENT OF ANY SIDEWALK, CURB & GUTTER, ASPHALT, LANDSCAPING ETC. DISTURBED OR DESTROYED DURING CONSTRUCTION.
2. CONTRACTOR SHALL MAINTAIN EMERGENCY AND UTILITY VEHICLE ACCESS AT ALL TIMES TO ALL EXISTING BUILDINGS AND BUILDING ENTRANCES
3. GENERAL CONTRACTOR SHALL VERIFY ALL EXISTING SITE CONDITIONS PRIOR TO BIDDING.
4. GENERAL CONTRACTOR SHALL PROTECT EXISTING BUILDING FROM DAMAGE DURING CONSTRUCTION.
5. EXISTING DRIVE APPROACHES TO REMAIN CLEAR AT ALL TIMES
6. ALL EXISTING SIDEWALKS TO REMAIN CLEAR AT ALL TIMES
7. ALL EXISTING CONCRETE AND ASPHALT PATHWAYS TO REMAIN OPEN TO PEDESTRIANS AND VEHICLES AT ALL TIMES DURING CONSTRUCTION
8. GENERAL CONTRACTOR SHALL PROTECT EXISTING BUILDING FROM DAMAGE DURING CONSTRUCTION.
9. GENERAL CONTRACTOR SHALL PROVIDE AN ENCLOSED DEBRIS SHOOT FOR THE REMOVAL OF CONSTRUCTION MATERIAL FROM THE ROOF.
10. GENERAL CONTRACTOR SHALL PROVIDE SELF CONTAINED TOILET FACILITIES AS PER SPECIFICATION ON ROOF LOCATIONS DURING CONSTRUCTION.



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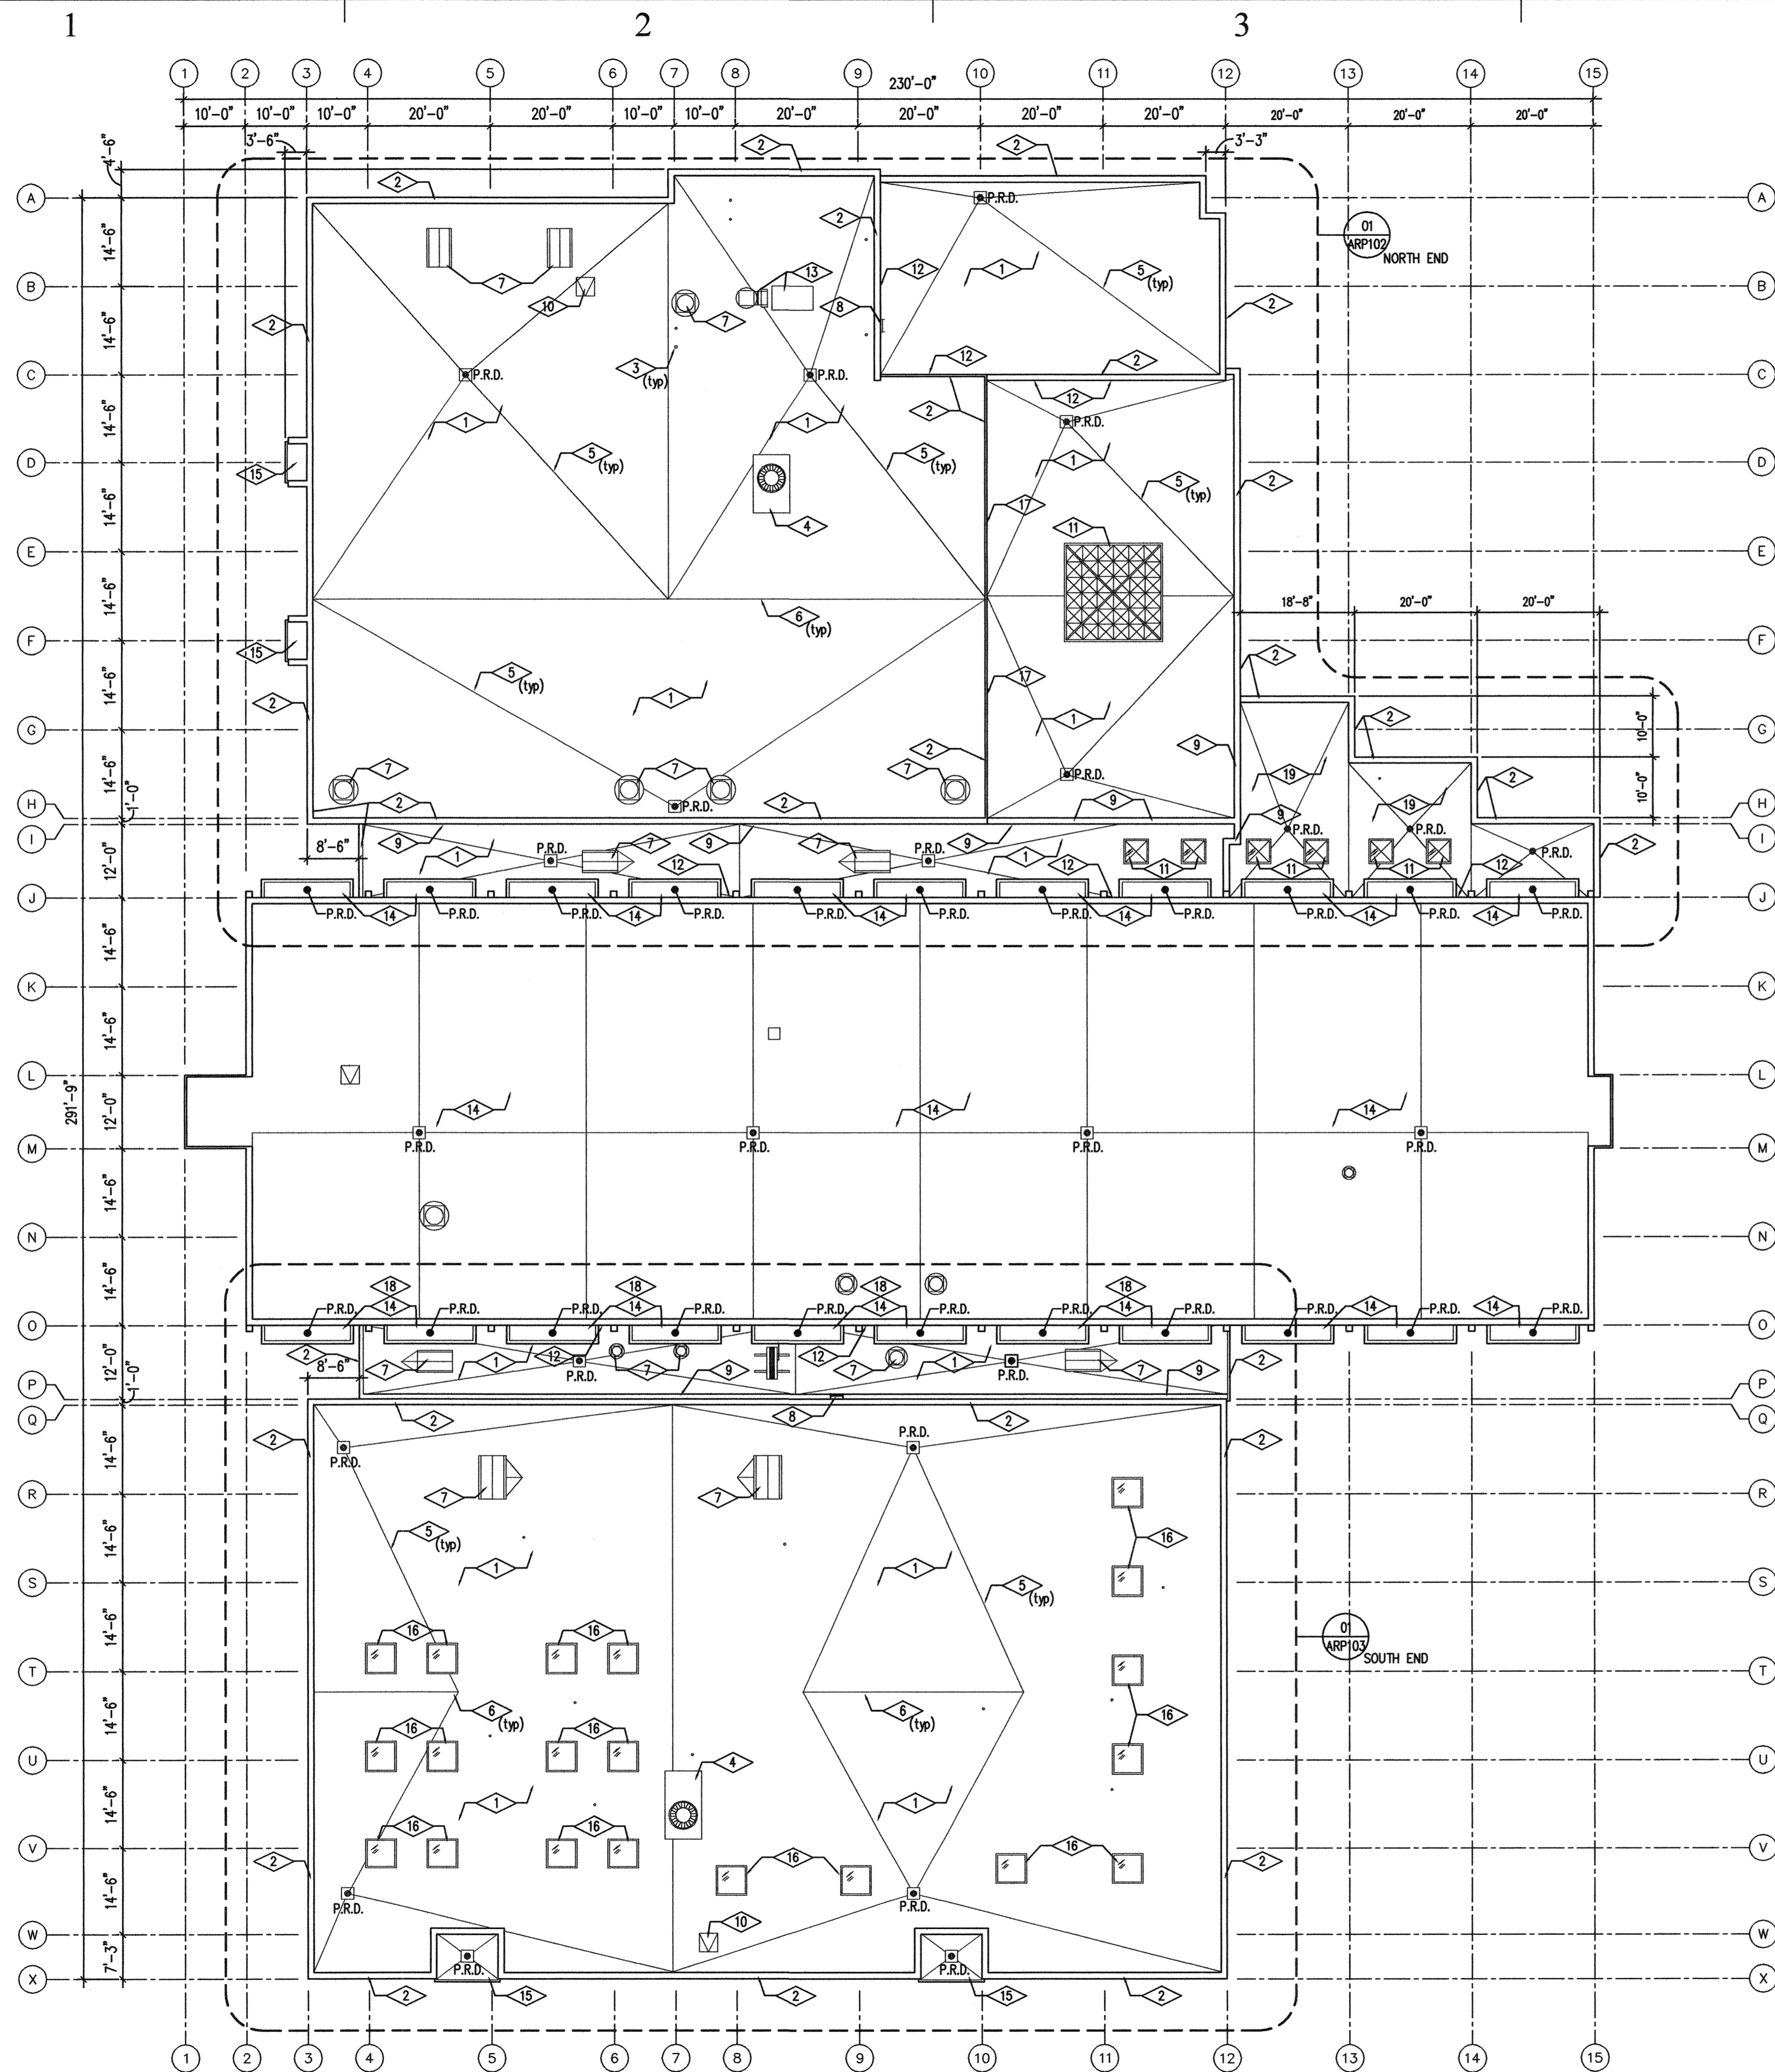
- 4 PROJECT LOCATION
- 5 GENERAL CONTRACTORS STAGING AREA
- 6 EXISTING CONCRETE AND ASPHALT PATHWAYS TO REMAIN OPEN TO PEDESTRIANS AND VEHICLES AT ALL TIMES DURING CONSTRUCTION
- 7 GENERAL CONTRACTORS PARKING AREA
- 8 CONTRACTOR VEHICLE ACCESS TO CONSTRUCTION SITE
- 9 EXISTING DRIVE APPROACHES TO REMAIN CLEAR AT ALL TIMES
- 10 EXISTING SIDEWALKS TO REMAIN CLEAR AT ALL TIMES
- 11 EXISTING AREA OF LANDSCAPING NOT TO BE DISTURBED
- 12 GENERAL CONTRACTOR SHALL DISCONNECT EXISTING IRRIGATION SYSTEM AT STAGING LOCATION AND DUMPSITE LOCATION THAT ARE SHOWN IN AREA OF EXISTING LANDSCAPING. UPON COMPLETION OF ROOFING PROJECT, GENERAL CONTRACTOR SHALL REMOVE EXISTING SOD AT DUMPSITE LOCATION AND STAGING LOCATION AND REPLACE WITH NEW SOD. GENERAL CONTRACTOR SHALL RECONNECT EXISTING IRRIGATION SYSTEM AND REPLACE ALL BROKEN SPRINKLER HEADS AND PIPING WITH SAME.
- 13 GENERAL CONTRACTOR SHALL PROVIDE SELF CONTAINED TOILET FACILITIES AS PER SPECIFICATION ON ROOF LOCATIONS DURING CONSTRUCTION.

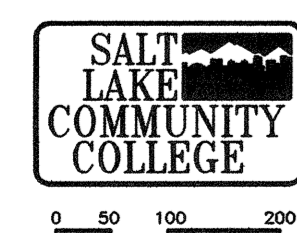

CAMPUS PLAN AND PROJECT LOCATION

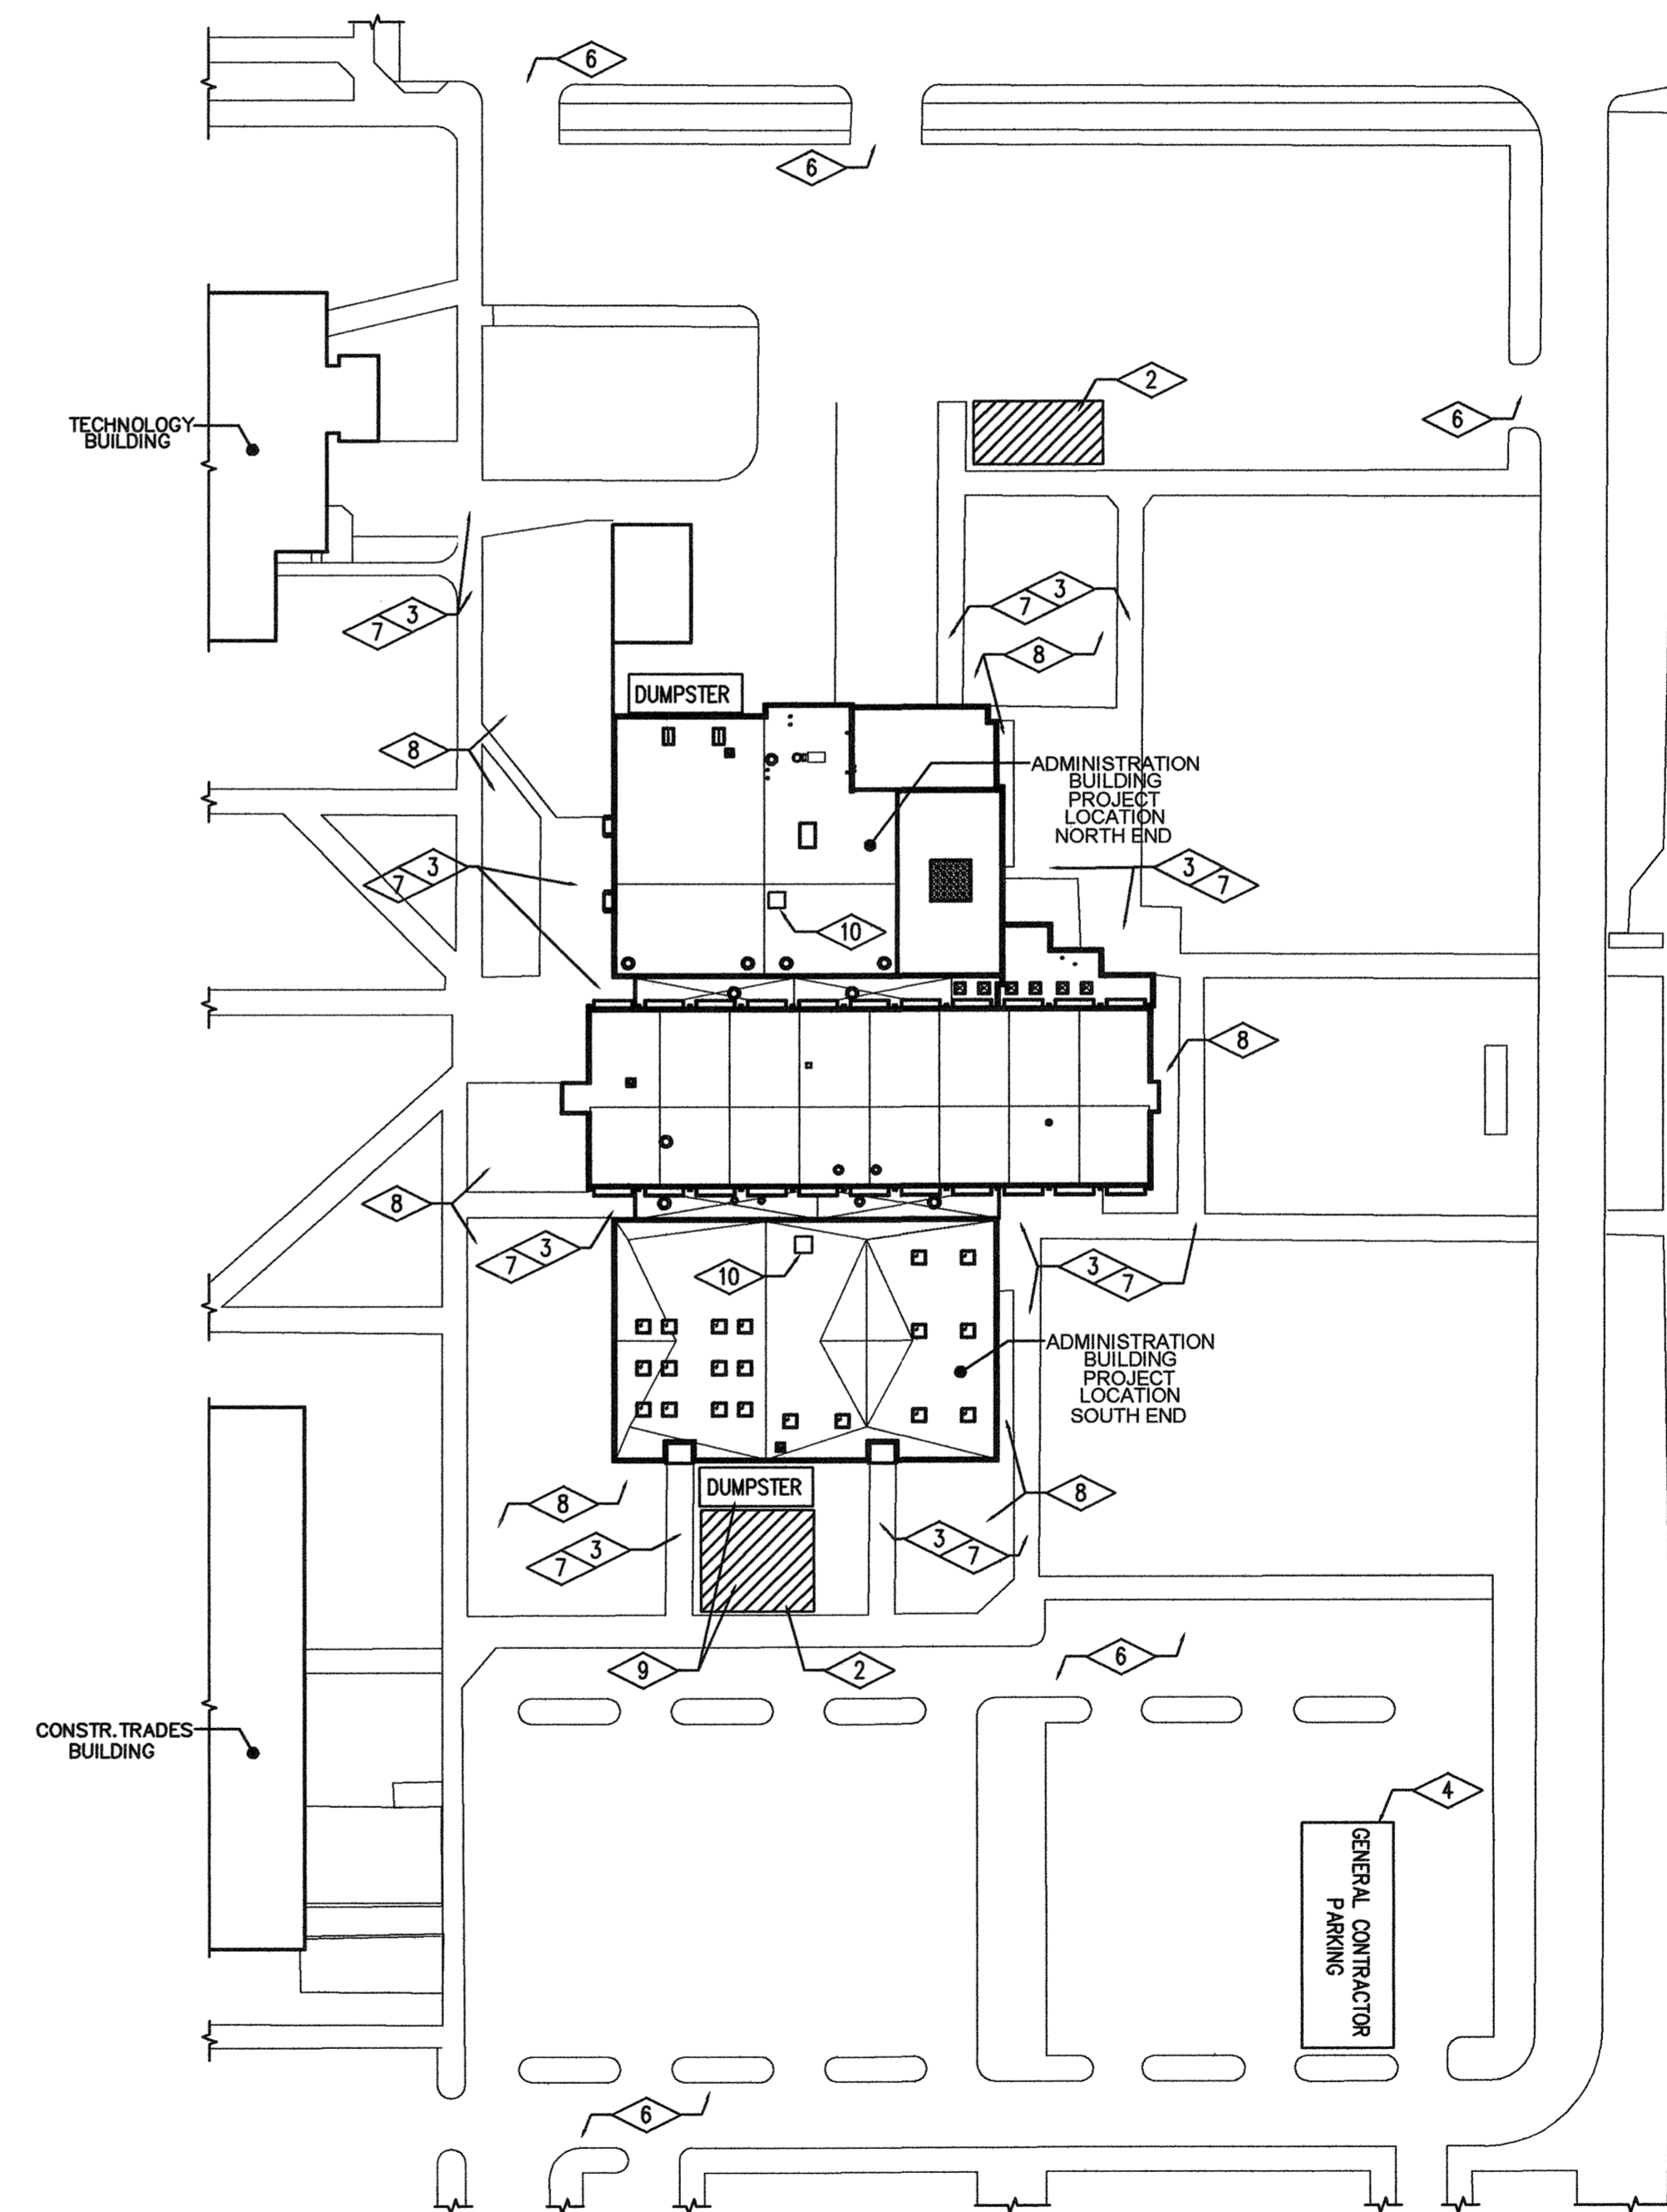

  **SITE PLAN**
SCALE N.T.S.



REFERENCE NOTES

- 1 EXISTING GRAVEL ROOF BALLAST AND 4 PLY ASPHALT BUILT UP ROOFING LAYERS TO BE REMOVED DOWN TO THE EXISTING PERLITE. GENERAL CONTRACTOR SHALL SWEEP ROOF THOROUGHLY CLEAN PRIOR TO APPLYING NEW DENS DECK ROOFING BOARD. ALL HOLES CREATED FROM THE REMOVAL OF THE EXISTING BUILT UP ASPHALT LAYERS LARGER THAN THE SPAN RATING OF THE NEW DENS DECK SHALL BE FILLED WITH POLYSTYRENE INSULATION. SEE NEW ROOF PLANS
- 2 EXISTING METAL CAP FLASHING TO BE REMOVED. EXISTING WOOD NAILERS TO REMAIN. EXISTING CANT STRIP TO BE REMOVED. SEE NEW ROOF PLAN AND DETAILS.
- 3 EXISTING VENT THROUGH ROOF TO REMAIN, SEE NEW ROOF PLAN AND DETAILS
- 4 GENERAL CONTRACTOR SHALL DISCONNECT EXISTING ELECTRICAL ROOF TOP A.C. UNITS AS REQUIRED TO PERFORM DEMOLITION OF EXISTING ROOF SYSTEM AND PROVIDE NEW ROOFING SYSTEM. GENERAL CONTRACTOR SHALL COORDINATE WITH FACILITIES PERSONAL PRIOR TO DISCONNECTING ELECTRICAL SUPPLY AND SHUTTING DOWN MECHANICAL UNIT.
- 5 EXISTING ROOF VALLEY LOCATION
- 6 EXISTING ROOF RIDGE LINE
- 7 EXISTING ROOF VENT SYSTEMS TO BE REMOVED AND REINSTALLED AS PER NEW ROOF PLAN AND NEW ROOF DETAILS
- 8 EXISTING ROOF ACCESS LADDER, SEE NEW ROOF PLAN FOR DESCRIPTION OF WORK FOR LADDERS
- 9 EXISTING ROOF EXPANSION JOINT LOCATION. EXISTING WOOD PARAPET EXPANSION JOINT, WOOD CANT STRIP AND ASSOCIATED METAL FLASHING TO BE REMOVED. SEE NEW ROOF PLANS AND EXPANSION JOINT DETAIL.
- 10 EXISTING ROOF HATCH SEE NEW ROOF PLANS AND DETAILS.
- 11 EXISTING SKYLIGHT TO BE LIFTED AND REINSTALLED AS REQUIRED FOR INSTALLATION OF NEW ROOF MEMBRANE
- 12 EXISTING COUNTER FLASHING AND CANT STRIP TO BE REMOVED. EXISTING MASONRY TO HAVE ROOFING TAR RESIDUE REMOVED PRIOR TO INSTALLATION OF NEW ROOFING SYSTEM, SEE NEW ROOF PLAN AND DETAILS
- 13 EXISTING MECHANICAL EQUIPMENT TO BE REMOVED. EXISTING ELECTRICAL TO BE DISCONNECTED. ALL ASSOCIATED CONDUIT, WIRE AND FITTINGS TO BE REMOVED BACK TO PANEL OR CLOSEST JUNCTION BOX. EXISTING ROOF PENETRATION TO BE COVERED AS PER NEW ROOF PLAN. REMOVE ALL ASSOCIATED DUCT WORK.
- 14 EXISTING UPPER ROOF SYSTEM NOT PART OF CONTRACT.
- 15 AT LOWER ROOFS THE GENERAL CONTRACTOR SHALL REMOVE EXISTING GRAVEL ROOF BALLAST. EXISTING B.U.R. LAYERS TO REMAIN. EXISTING FLASHINGS, COUNTER FLASHINGS, CAP FLASHINGS AND CANT STRIPS TO BE REMOVED. GENERAL CONTRACTOR SHALL SWEEP ROOF THOROUGHLY CLEAN PRIOR TO APPLYING NEW DENS DECK ROOFING BOARD. SEE NEW ROOF PLAN AND NEW ROOF DETAILS.
- 16 EXISTING SKYLIGHTS TO BE REMOVED AND REINSTALLED AS REQUIRED FOR NEW ROOFING SYSTEM MEMBRANE INSTALLATION AS PART OF BASE BID. NEW SKYLIGHTS TO BE PROVIDED AS PER ADD. ALT NO.1 SEE NEW ROOF PLANS, DETAILS AND SPECIFICATIONS.
- 17 EXISTING COUNTER FLASHING AND CANT STRIP TO BE REMOVED. EXISTING WINDOW FRAME SYSTEM TO HAVE ROOFING TAR RESIDUE REMOVED PRIOR TO INSTALLATION OF NEW ROOFING SYSTEM, SEE NEW ROOF PLAN AND DETAILS
- 18 EXISTING BIRD SCREENS AND WOOD SLEEPERS AT ROOF OVERHANGS TO BE REMOVED AND STORED IN A PROTECTIVE AREA. BIRD SCREENS AND NEW TREATED WOOD TO BE REINSTALLED AFTER INSTALLATION OF NEW ROOF MEMBRANE.
- 19 EXISTING ASPHALT ROOFING TO BE REMOVED TO TOP OF EXISTING POLYISO.

GENERAL NOTES

1. CONTRACTOR MUST VISIT THE SITE SO AS TO BE FAMILIAR WITH ALL EXISTING CONDITIONS. BRING ANY QUESTIONS OR CONCERNS TO THE ATTENTION OF THE PROJECT MANAGER FOR CLARIFICATION, FOR ADDENDUM PRIOR TO BID OPENING. NO ALLOWANCES WILL BE MADE FOR CONDITIONS THAT ARE CLEARLY VISIBLE.
2. CONTRACTOR SHALL WORK WITH LOCAL LEADERSHIP ON SCHEDULING TO INSURE CONTINUED USE OF THE BUILDING. NEITHER THE CONTRACTOR NOR ANY OF HIS PEOPLE SHALL HAVE ACCESS TO THE BUILDING WITHOUT PRIOR AUTHORIZATION.
3. ALL SAFETY STANDARD AND REQUIREMENTS ARE THE RESPONSIBILITY OF THE CONTRACTOR.
4. CONTRACTOR RESPONSIBLE TO KEEP BUILDING WATER TIGHT AT ALL TIMES. STARTING FROM NOTICE TO PROCEED TO SUBSTANTIAL COMPLETION ANY DAMAGE TO THE BUILDING OF ITS CONTENTS WILL BE THE RESPONSIBILITY OF THE CONTRACTOR.
5. CONTRACTOR TO CHECK ALL MECHANICAL EQUIPMENT BEFORE DISCONNECTING TO MAKE SURE THEY ARE OPERATING PROPERLY. CONTRACTOR IS RESPONSIBLE FOR UNITS TO BE IN COMPLETE OPERATING CONDITION AT THE COMPLETION OF THE PROJECT. COORDINATE SHUTDOWN WITH USERS.
6. ALL PIPES, CONDUITS AND MECHANICAL UNITS TO REMAIN ON ROOF ARE TO BE PROTECTED AND KEPT CLEAN THROUGH THE END OF CONSTRUCTION.
7. GENERAL CONTRACTOR SHALL USE EXISTING WOOD NAILERS FOR NEW ROOFING SYSTEM.
8. GENERAL CONTRACTOR SHALL PROVIDE AN ENCLOSED DEBRIS SHOOT FOR THE REMOVAL OF ALL ROOFING MATERIAL. THE GENERAL CONTRACTOR SHALL PROVIDE PROTECTION FOR THE EXISTING BUILDING, WALK WAYS AND SURROUNDING SITE AS NECESSARY FROM DAMAGE THAT MAY RESULT FROM THE REMOVAL OF THE ROOFING MATERIALS.
9. GENERAL CONTRACTOR SHALL KEEP ALL WALKWAYS OPEN DURING THE CONSTRUCTION PERIOD. ABSOLUTELY NO MATERIAL SHALL BE DROPPED, OR THROWN FROM THE ROOF.
10. ALL EXISTING VENT STACKS TO REMAIN. GENERAL CONTRACTOR SHALL EXTEND EXISTING VENT STACK AS PER NEW ROOF PLAN DRAWINGS AND DETAILS.
11. GENERAL CONTRACTOR SHALL THOROUGHLY INSPECT EXISTING ROOF FOR BIRD EXCREMENT. ALL EXISTING BIRD EXCREMENT SHALL BE REMOVED IN AREAS OF CONSTRUCTION AS PER THE STATE OF UTAH'S GUIDELINES FOR CLEANUP OF BIRD AND BAT EXCREMENT. GENERAL CONTRACTOR SHALL NOTE THE GUIDE LINES FOR THE REMOVAL OF BIRD AND BAT EXCREMENT ARE PROVIDED IN THE CONSTRUCTION SPECIFICATIONS.

LEDGEND

P.R.D. ● EXISTING PRIMARY ROOF DRAINS TO REMAIN

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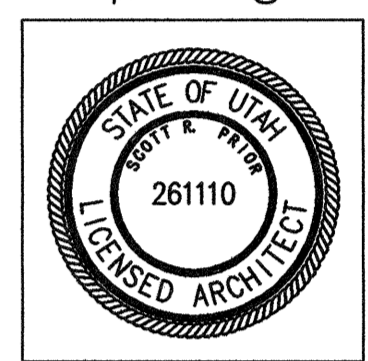
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COMMUNITY COLLEGE

4600 SOUTH
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TAYLORSVILLE, UTAH

ADMINISTRATION BUILDING

PROJECT TITLE:

SALT LAKE
COMMUNITY COLLEGE
REDWOOD ROAD CAMPUS
ADMINISTRATION BUILDING
ROOFING IMPROVEMENTS

MARK DATE DESCRIPTION

ISSUE TYPE: CONSTRUCTION DOCUMENTS

ISSUE DATE: 07th May, 2007

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CAD PROJECT NO:

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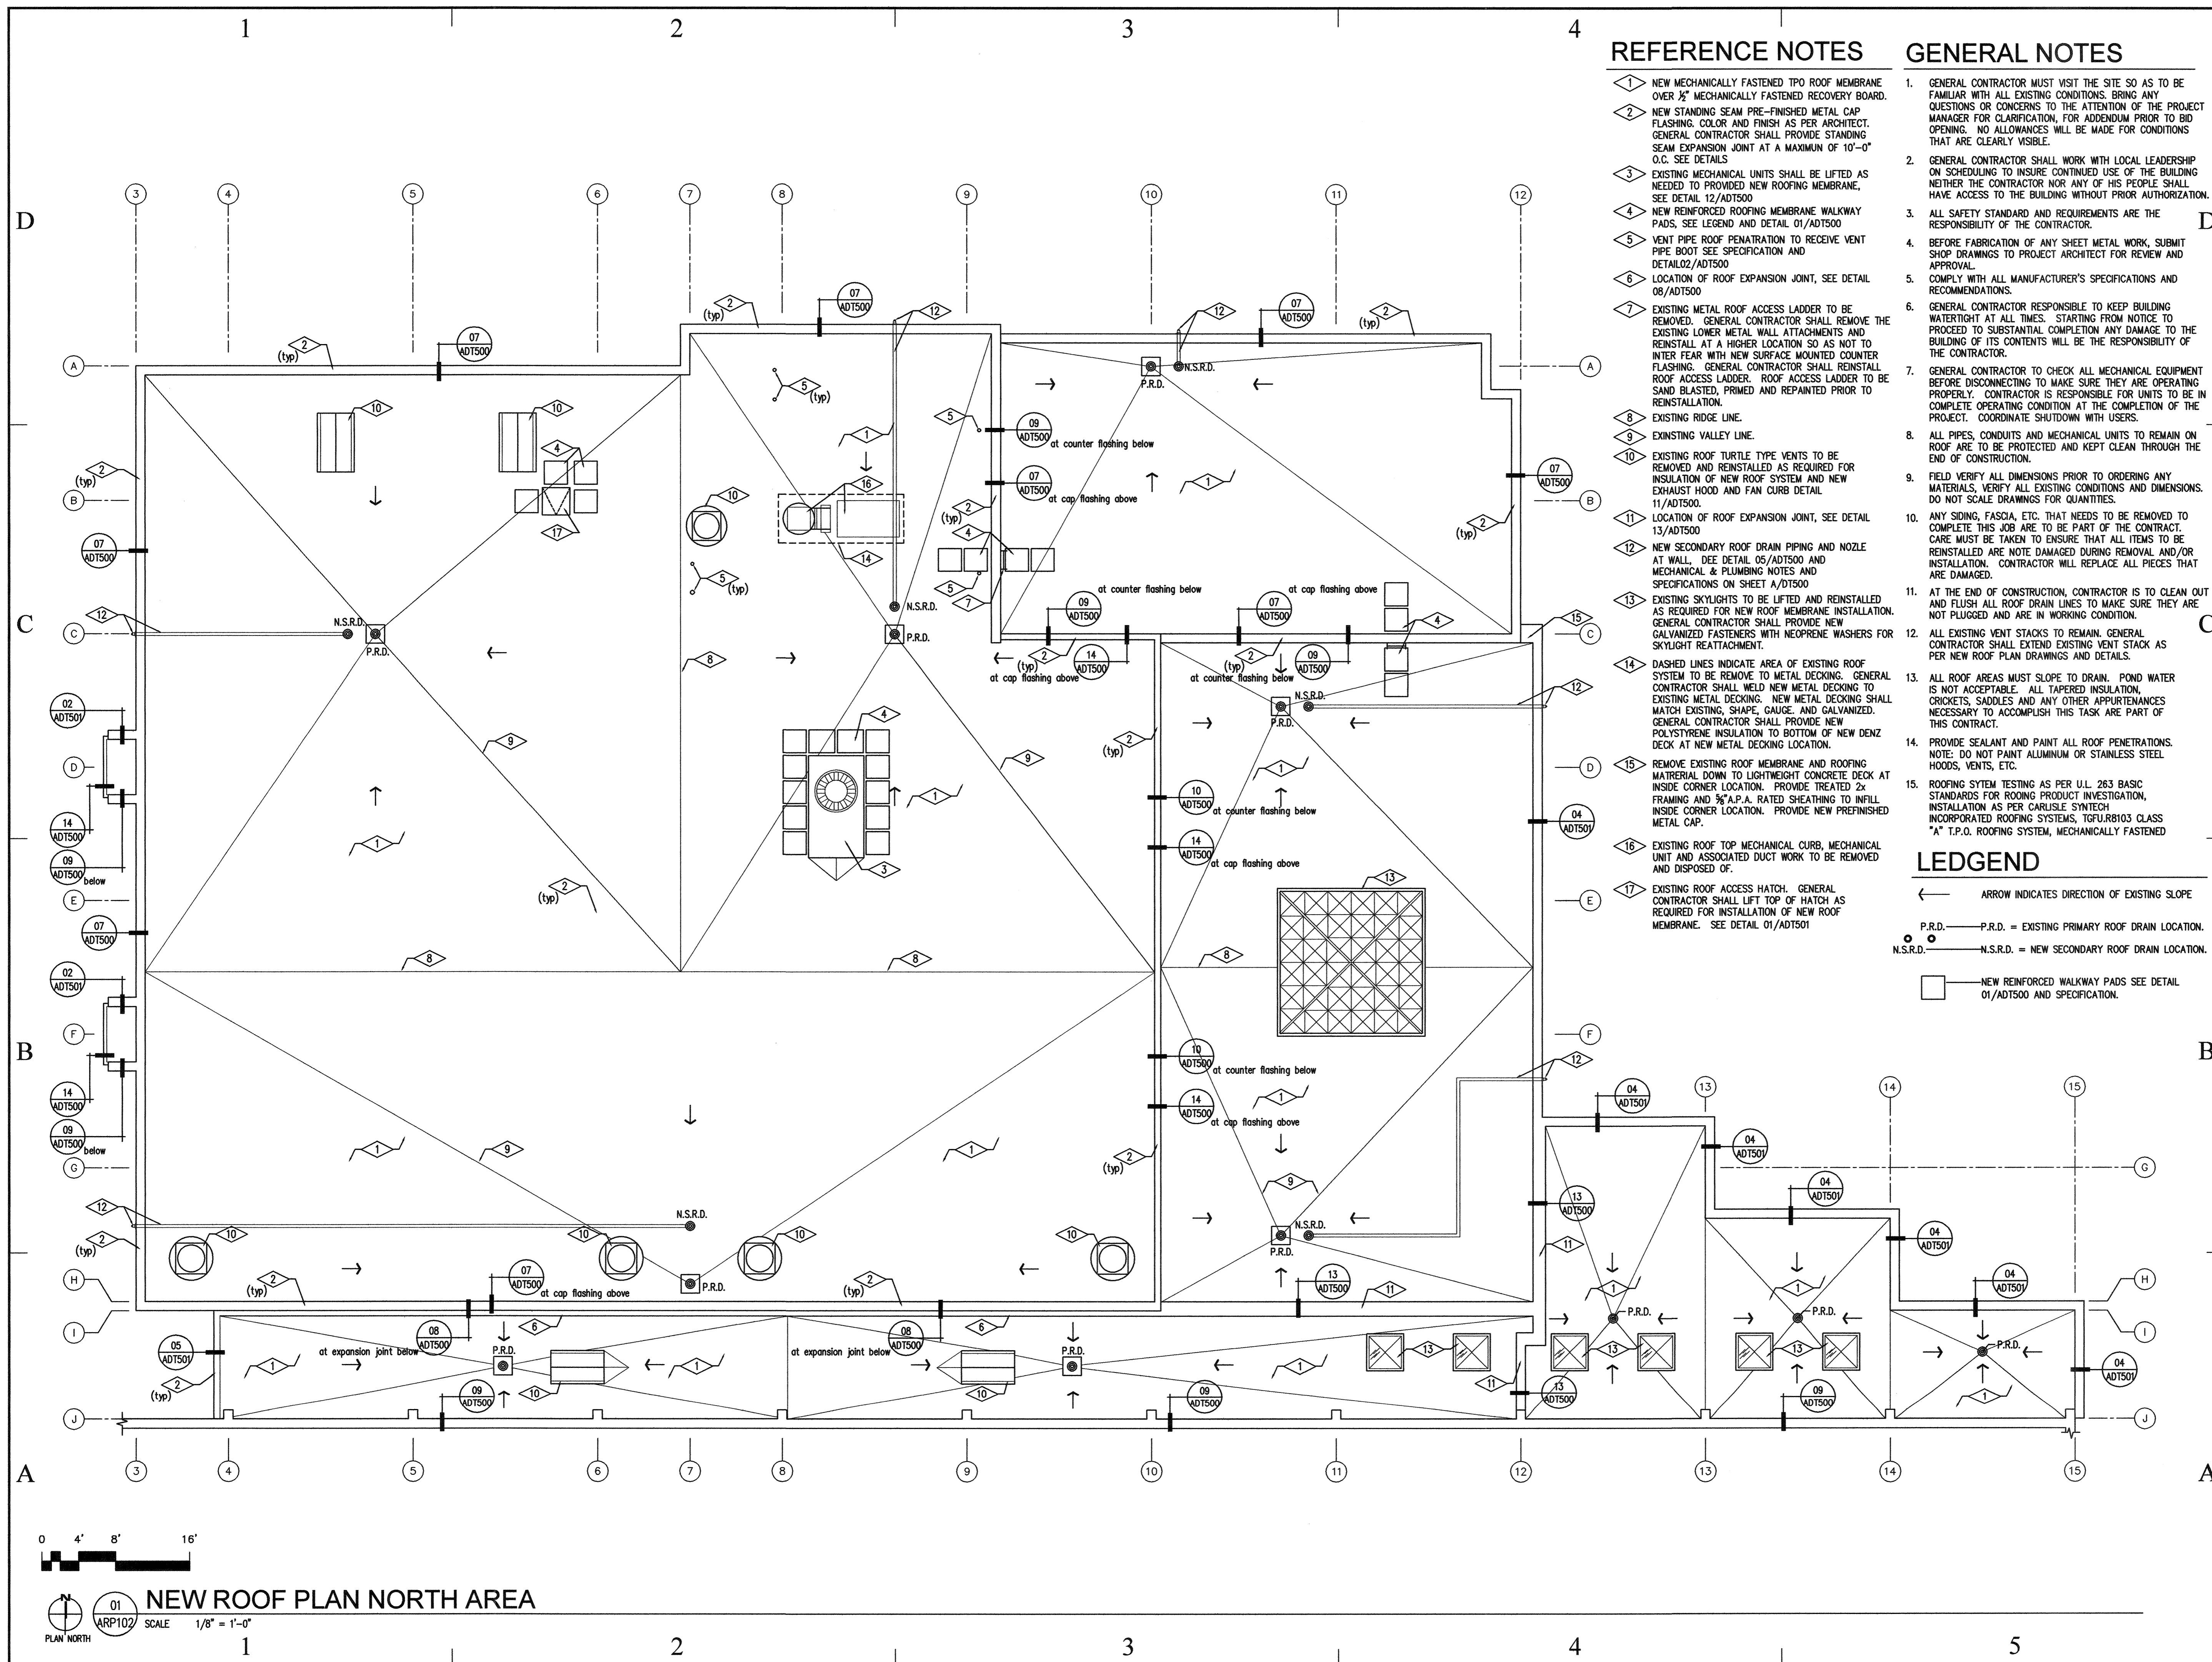
SHEET TITLE

DEMOLITION
ROOF PLAN

SHEET NUMBER

A-DP101

SHEET 4 OF 9



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Department of Administrative Services



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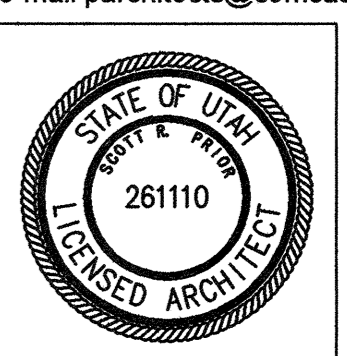
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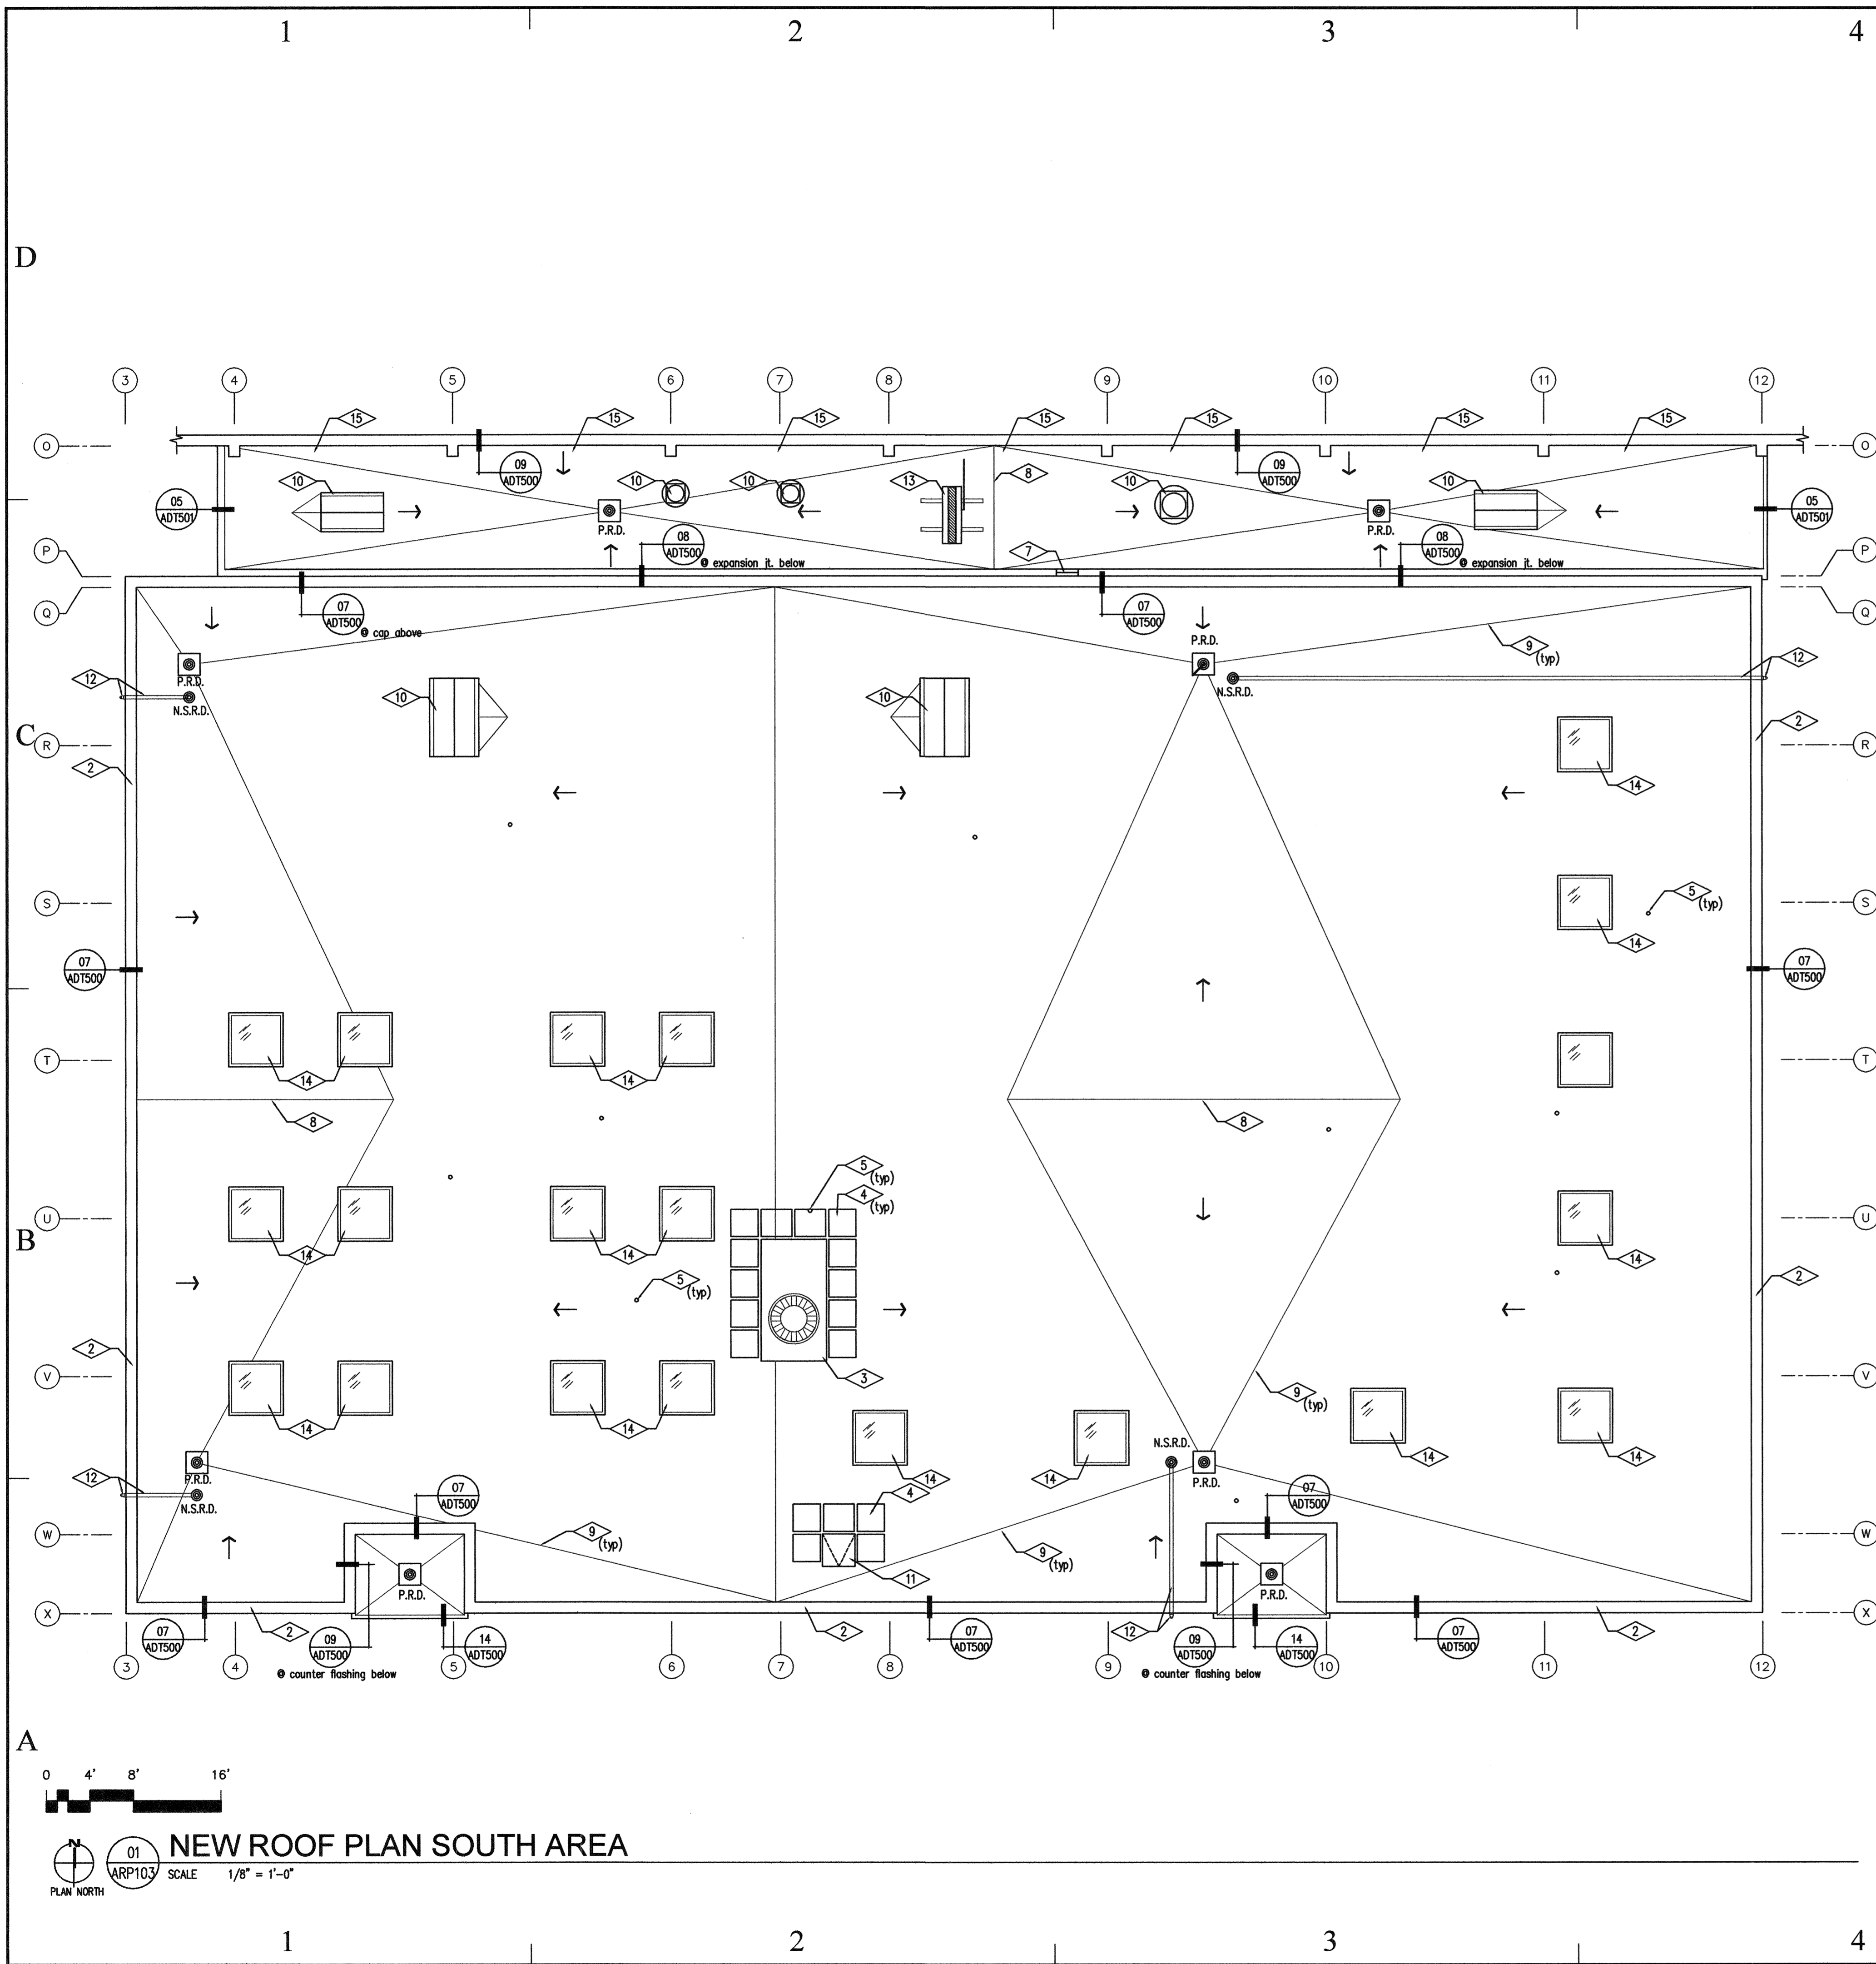
SHEET TITLE

**NEW
ROOF PLAN
NORTH ROOF**

SHEET NUMBER

A-RP102

SHEET 6 OF 9



REFERENCE NOTES

- NEW MECHANICALLY FASTENED TPO ROOF MEMBRANE OVER 1/2" MECHANICALLY FASTENED RECOVERY BOARD.
- NEW STANDING SEAM PRE-FINISHED METAL CAP FLASHING. COLOR AND FINISH AS PER ARCHITECT. GENERAL CONTRACTOR SHALL PROVIDE STANDING SEAM EXPANSION JOINT AT A MAXIMUM OF 10'-0" O.C. SEE DETAILS.
- EXISTING MECHANICAL UNITS SHALL BE LIFTED AS NEEDED TO PROVIDED NEW ROOFING MEMBRANE, SEE DETAIL 12/ADT500
- NEW REINFORCED ROOFING MEMBRANE WALKWAY PADS, SEE LEGEND AND DETAIL 01/ADT500
- VENT PIPE ROOF PENETRATION TO RECEIVE VENT PIPE BOOT SEE SPECIFICATION AND DETAIL02/ADT500
- LOCATION OF ROOF EXPANSION JOINT, SEE DETAIL 08/ADT500
- EXISTING METAL ROOF ACCESS LADDER TO BE REMOVED. GENERAL CONTRACTOR SHALL REMOVE THE EXISTING LOWER METAL WALL ATTACHMENTS AND REINSTALL AT A HIGHER LOCATION SO AS NOT TO INTERFERE WITH NEW SURFACE MOUNTED COUNTER FLASHING. GENERAL CONTRACTOR SHALL REINSTALL ROOF ACCESS LADDER. ROOF ACCESS LADDER TO BE SAND BLASTED, PRIMED AND REPAINTED PRIOR TO REINSTALLATION.
- EXISTING RIDGE LINE.
- EXISTING VALLEY LINE.
- EXISTING ROOF VENTS TO BE REMOVED AND REINSTALLED AS REQUIRED FOR INSULATION OF NEW ROOF SYSTEM AND NEW EXHAUST HOOD AND FAN CURB DETAIL 11/ADT500.
- EXISTING ROOF ACCESS HATCH. GENERAL CONTRACTOR SHALL LIFT TOP OF HATCH AS REQUIRED FOR INSTALLATION OF NEW ROOF MEMBRANE. SEE DETAIL 01/ADT501
- NEW SECONDARY ROOF DRAIN PIPING AND NOZZLE AT WALL. SEE DETAIL 05/ADT500 AND MECHANICAL & PLUMBING NOTES AND SPECIFICATIONS ON SHEET A/DT500
- EXISTING MECHANICAL UNITS SHALL BE LIFTED AS NEEDED TO PROVIDED NEW ROOFING MEMBRANE, SEE DETAIL 11/ADT500 FOR NEW MECHANICAL CURB DETAIL.
- EXISTING SKYLIGHTS TO BE REMOVED AND REINSTALLED AS REQUIRED FOR INSTALLATION OF NEW MEMBRANE ROOFING SYSTEM AS PER BASE BID. GENERAL CONTRACTOR SHALL PROVIDE UNIT PRICING AS PER ADD ALTERNATE NO. 1. IN SPECIFICATION SECTION 01030 AND NEW SKYLIGHTS AS PER DETAIL 03/ADT501 AND SPECIFICATION SECTION 08620
- GENERAL CONTRACTOR SHALL REINSTALL THE ORIGINAL BIRD SCREENS ON NEW 4"x4" PRESSURE TREATED WOOD SLEEPERS.

GENERAL NOTES

- GENERAL CONTRACTOR MUST VISIT THE SITE SO AS TO BE FAMILIAR WITH ALL EXISTING CONDITIONS. BRING ANY QUESTIONS OR CONCERNS TO THE ATTENTION OF THE PROJECT MANAGER FOR CLARIFICATION, FOR ADDENDUM PRIOR TO BID OPENING. NO ALLOWANCES WILL BE MADE FOR CONDITIONS THAT ARE CLEARLY VISIBLE.
- GENERAL CONTRACTOR SHALL WORK WITH LOCAL LEADERSHIP ON SCHEDULING TO INSURE CONTINUED USE OF THE BUILDING NEITHER THE CONTRACTOR NOR ANY OF HIS PEOPLE SHALL HAVE ACCESS TO THE BUILDING WITHOUT PRIOR AUTHORIZATION.
- ALL SAFETY STANDARD AND REQUIREMENTS ARE THE RESPONSIBILITY OF THE CONTRACTOR.
- BEFORE FABRICATION OF ANY SHEET METAL WORK, SUBMIT SHOP DRAWINGS TO PROJECT ARCHITECT FOR REVIEW AND APPROVAL.
- COMPLY WITH ALL MANUFACTURER'S SPECIFICATIONS AND RECOMMENDATIONS.
- GENERAL CONTRACTOR RESPONSIBLE TO KEEP BUILDING WATERIGHT AT ALL TIMES. STARTING FROM NOTICE TO PROCEED TO SUBSTANTIAL COMPLETION ANY DAMAGE TO THE BUILDING OF ITS CONTENTS WILL BE THE RESPONSIBILITY OF THE CONTRACTOR.
- GENERAL CONTRACTOR TO CHECK ALL MECHANICAL EQUIPMENT BEFORE DISCONNECTING TO MAKE SURE THEY ARE OPERATING PROPERLY. CONTRACTOR IS RESPONSIBLE FOR UNITS TO BE IN COMPLETE OPERATING CONDITION AT THE COMPLETION OF THE PROJECT. COORDINATE SHUTDOWN WITH USERS.
- ALL PIPES, CONDUITS AND MECHANICAL UNITS TO REMAIN ON ROOF ARE TO BE PROTECTED AND KEPT CLEAN THROUGH THE END OF CONSTRUCTION.
- FIELD VERIFY ALL DIMENSIONS PRIOR TO ORDERING ANY MATERIALS, VERIFY ALL EXISTING CONDITIONS AND DIMENSIONS. DO NOT SCALE DRAWINGS FOR QUANTITIES.
- ANY SIDING, FASCIA, ETC. THAT NEEDS TO BE REMOVED TO COMPLETE THIS JOB ARE TO BE PART OF THE CONTRACT. CARE MUST BE TAKEN TO ENSURE THAT ALL ITEMS TO BE REINSTALLED ARE NOT DAMAGED DURING REMOVAL AND/OR INSTALLATION. CONTRACTOR WILL REPLACE ALL PIECES THAT ARE DAMAGED.
- AT THE END OF CONSTRUCTION, CONTRACTOR IS TO CLEAN OUT AND FLUSH ALL ROOF DRAIN LINES TO MAKE SURE THEY ARE NOT PLUGGED AND ARE IN WORKING CONDITION.
- ALL EXISTING VENT STACKS TO REMAIN. GENERAL CONTRACTOR SHALL EXTEND EXISTING VENT STACK AS PER NEW ROOF PLAN DRAWINGS AND DETAILS.
- ALL ROOF AREAS MUST SLOPE TO DRAIN. POND WATER IS NOT ACCEPTABLE. ALL TAPERED INSULATION, CRICKETS, SADDLES AND ANY OTHER APPURTENANCES NECESSARY TO ACCOMPLISH THIS TASK ARE PART OF THIS CONTRACT.
- PROVIDE SEALANT AND PAINT ALL ROOF PENETRATIONS. NOTE: DO NOT PAINT ALUMINUM OR STAINLESS STEEL HOODS, VENTS, ETC.
- ROOFING SYTEM TESTING AS PER U.L. 263 BASIC STANDARDS FOR ROOFING PRODUCT INVESTIGATION, INSTALLATION AS PER CARUSLE SYNTICH INCORPORATED ROOFING SYSTEMS, TGFUR8103 CLASS "A" T.P.O. ROOFING SYSTEM, MECHANICALLY FASTENED

LEDGEND

- ARROW INDICATES DIRECTION OF EXISTING SLOPE
- P.R.D. = P.R.D. = EXISTING PRIMARY ROOF DRAIN LOCATION.
N.S.R.D. = N.S.R.D. = NEW SECONDARY ROOF DRAIN LOCATION.
- NEW REINFORCED WALKWAY PADS SEE DETAIL 01/ADT500 AND SPECIFICATION.

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SHEET TITLE

**NEW
ROOF PLAN
SOUTH END**


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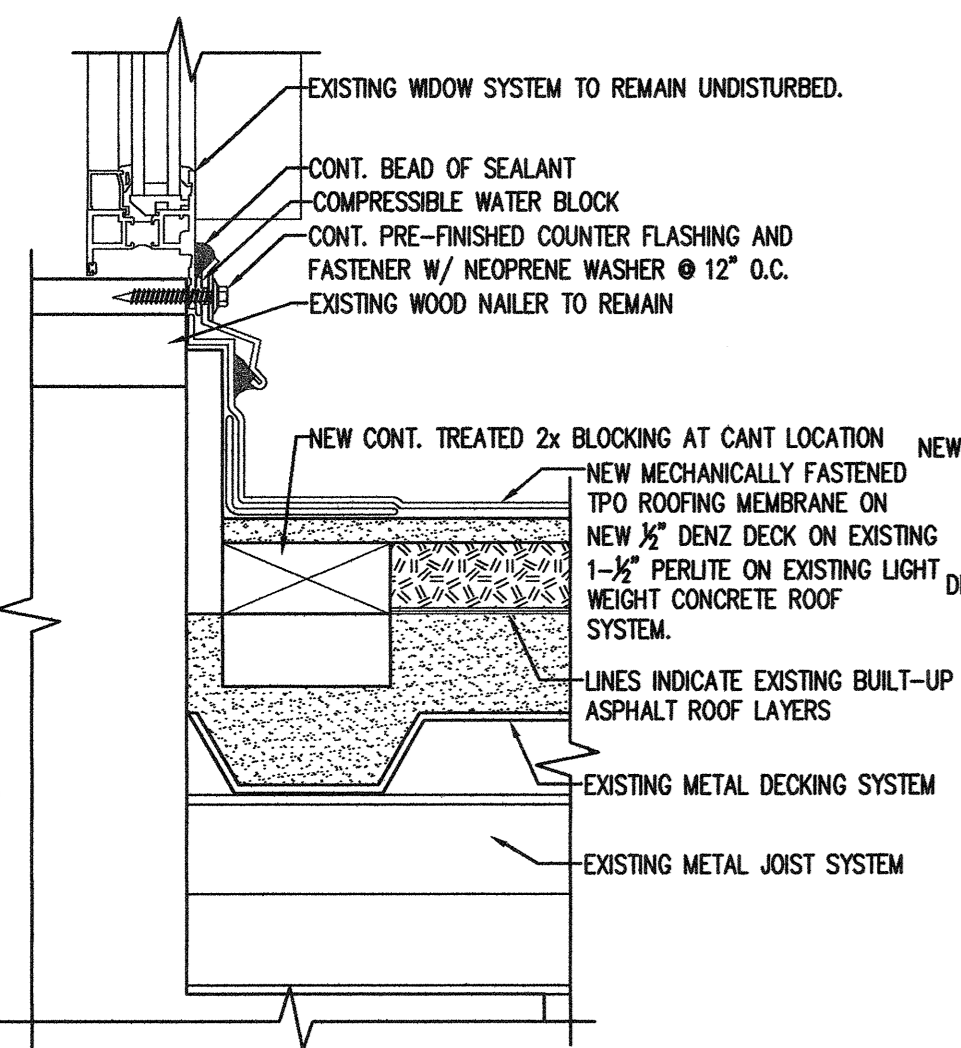
SHEET 7 OF 9

PLUMBING SPECIFICATIONS			
SYMBOL	DESCRIPTION / SPECIFICATION	MANUFACTURER	MODEL NUMBER
NSRD	SECONDARY (EMERGENCY) ROOF DRAIN: CAST IRON BODY, CAST IRON DOME WITH LOCKING SCREWS, 2" HIGH EXTERIOR WATER DAM, BEARING PAN, SUMP RECEIVER, EXTENSION PIECE, UNDER DECK CLAMP, OUTLET SIZE AS INDICATED ON DRAWINGS.	ZURN SMITH MIFAB	Z121 1310-OD R1200-M
DN	DOWNSPOUT NOZZLE: NICKEL BRONZE BODY AND WALL FLANGE WITH DECORATIVE FACE AND OUTLET NOZZLE, THREADED INLET, STAINLESS STEEL SCREEN.	ZURN SMITH MIFAB	Z199-SS 1770-NB-SS R1940-83
	ROOF DRAIN PIPING: HUBLESS CAST IRON PIPE TO CONFORM TO THE REQUIREMENTS OF CSPI STANDARD 301, ASTM A-888 OR ASTM A-74 AND SHALL BE CAST IRON SOIL PIPE AND FITTINGS.	TYLER CHARLOTTE A&B	
	ROOF DRAIN PIPE FITTINGS: HUBLESS CAST IRON PIPE FITTING JOINTS SHALL CONFORM TO THE REQUIREMENTS OF CSPI STANDARD 310, ASTM STANDARD C-564 AND LOCAL CODE REQUIREMENTS.	TYLER CHARLOTTE A&B HUSKY	
	PIPING INSULATION: PREFORMED FIBERGLASS INSULATION, ASTM C547, ALL SERVICE JACKET, SELF SEALING LAP, 1" THICKNESS, TAPED AND SEALED JOINTS.	ARMSTRONG CERTAINTED CORP. KNAUF MANVILLE OWENS-CORNING	


MECHANICAL / PLUMBING GENERAL NOTES	
1.	THE CONTRACTOR SHALL VERIFY ALL PLUMBING FIXTURES, EQUIPMENT REQUIREMENTS AND LOCATIONS, AND ALL RELATED UTILITIES WITH THE ARCHITECTURAL PLANS AND SPECIFICATIONS AND SHALL PROVIDE ALL SERVICES AS REQUIRED.
2.	ALL PLUMBING SHALL BE DONE IN ACCORDANCE WITH THE LATEST ADOPTED EDITION OF THE UTAH PLUMBING CODE AND/OR LOCAL ORDINANCES (INTERNATIONAL PLUMBING CODE, 2006).
3.	ALL FIXTURES SHALL BE AS SPECIFIED ON PLUMBING FIXTURE SCHEDULE.
4.	ALL MECHANICAL WORK SHALL BE DONE IN ACCORDANCE WITH THE LATEST ADOPTED EDITION OF THE UTAH MECHANICAL CODE AND/OR LOCAL ORDINANCE (INTERNATIONAL CODE, 2006).




14 PARAPET DETAIL
SCALE 3" = 1'-0"

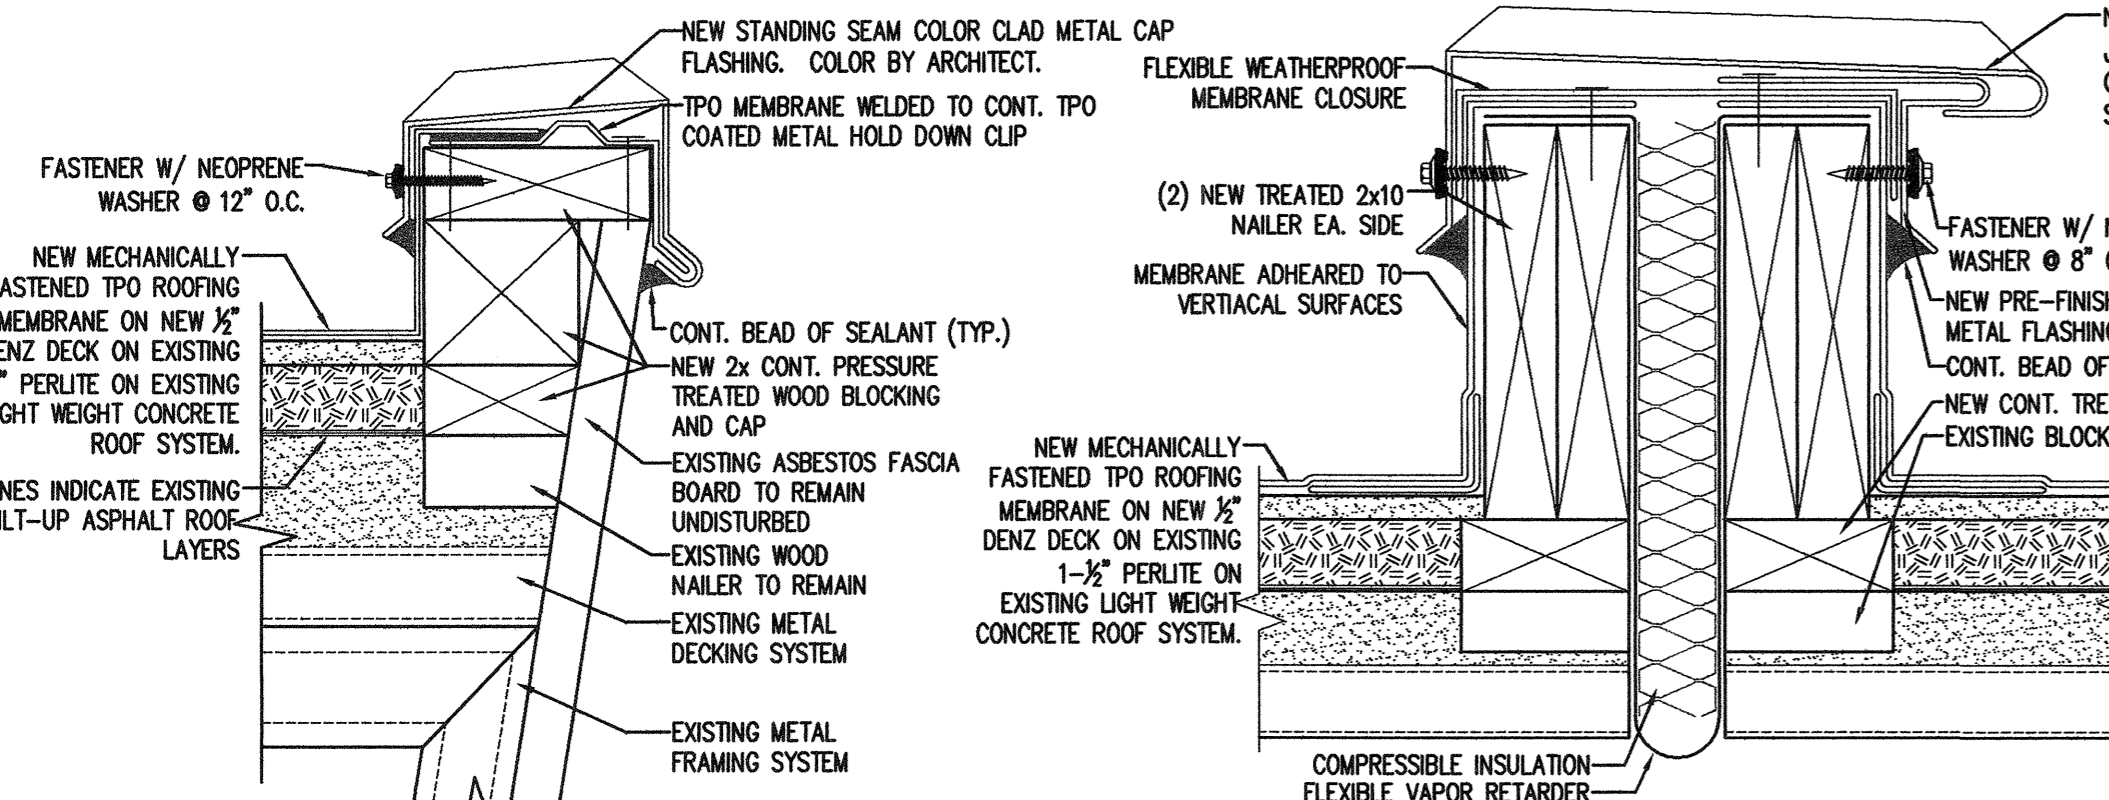


10 BASE FLASHING
SCALE 3" = 1'-0"

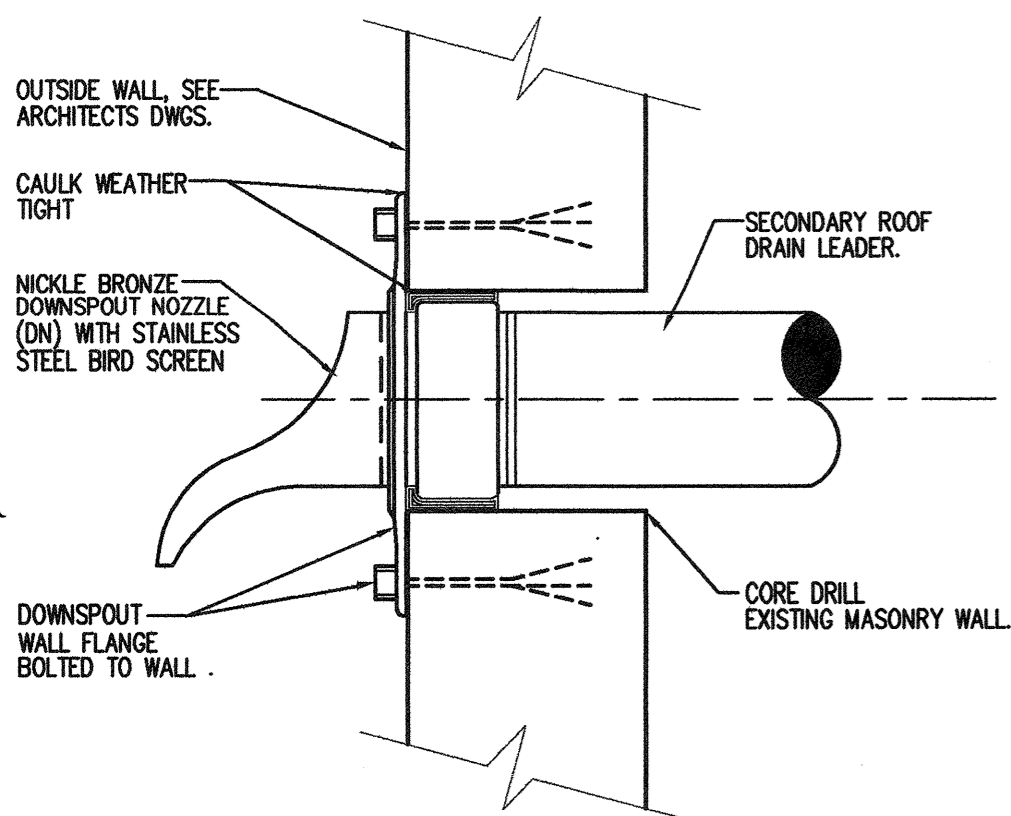


05 SEC. NOZZLE AT WALL
SCALE N.T.S.

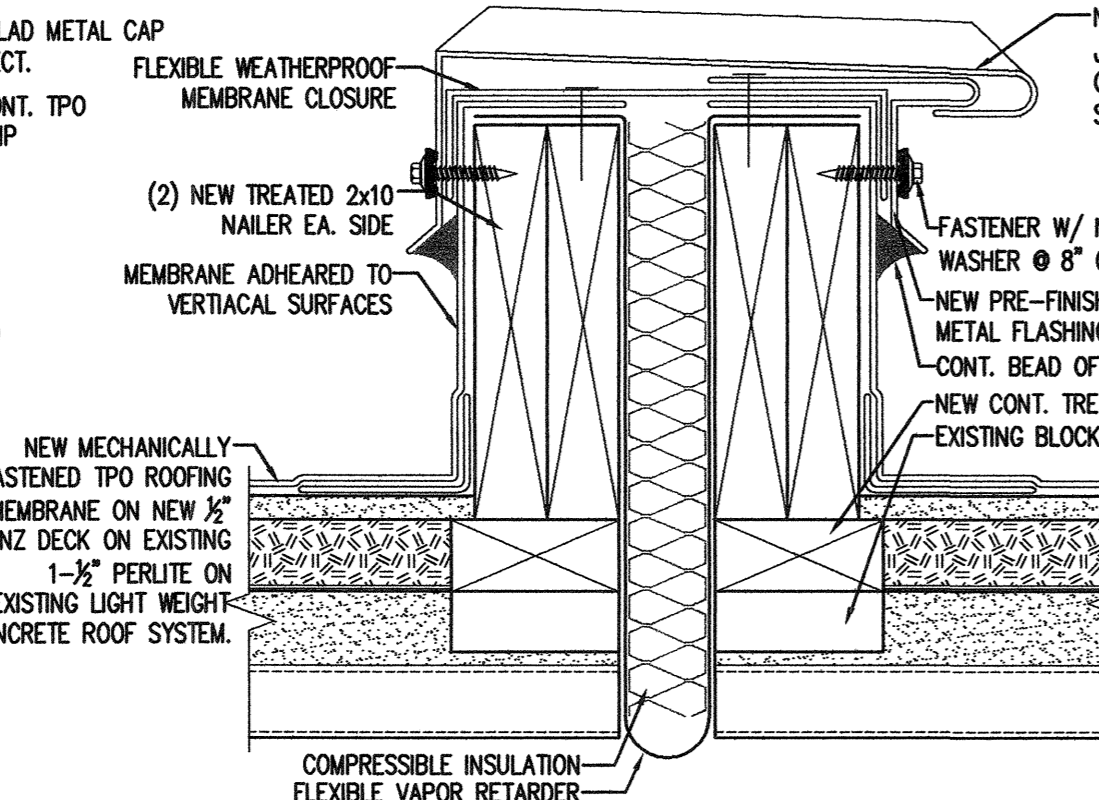


13 SECTION @ EXP. JNT.
SCALE 3" = 1'-0"

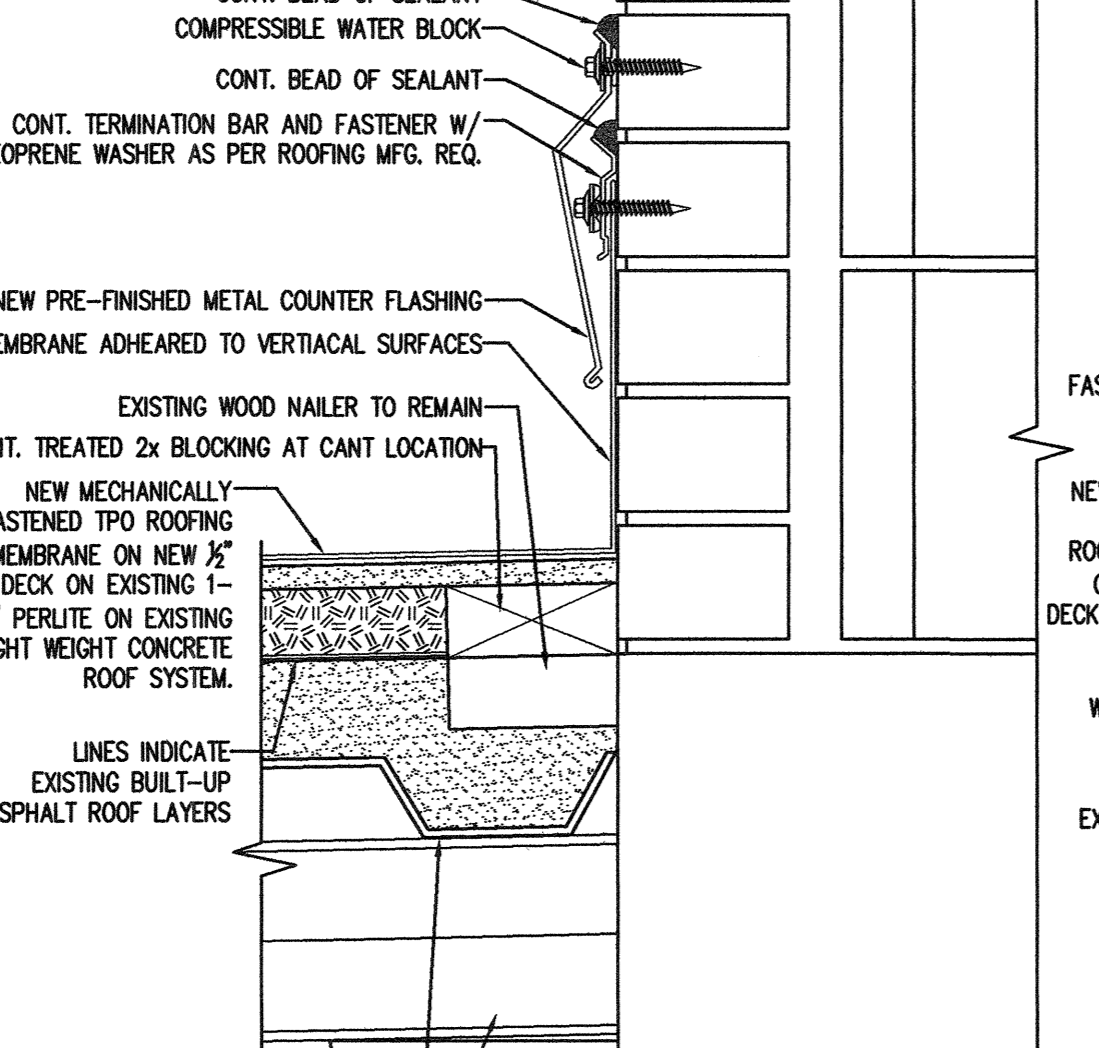


09 COUNTER FLASHING
SCALE 3" = 1'-0"

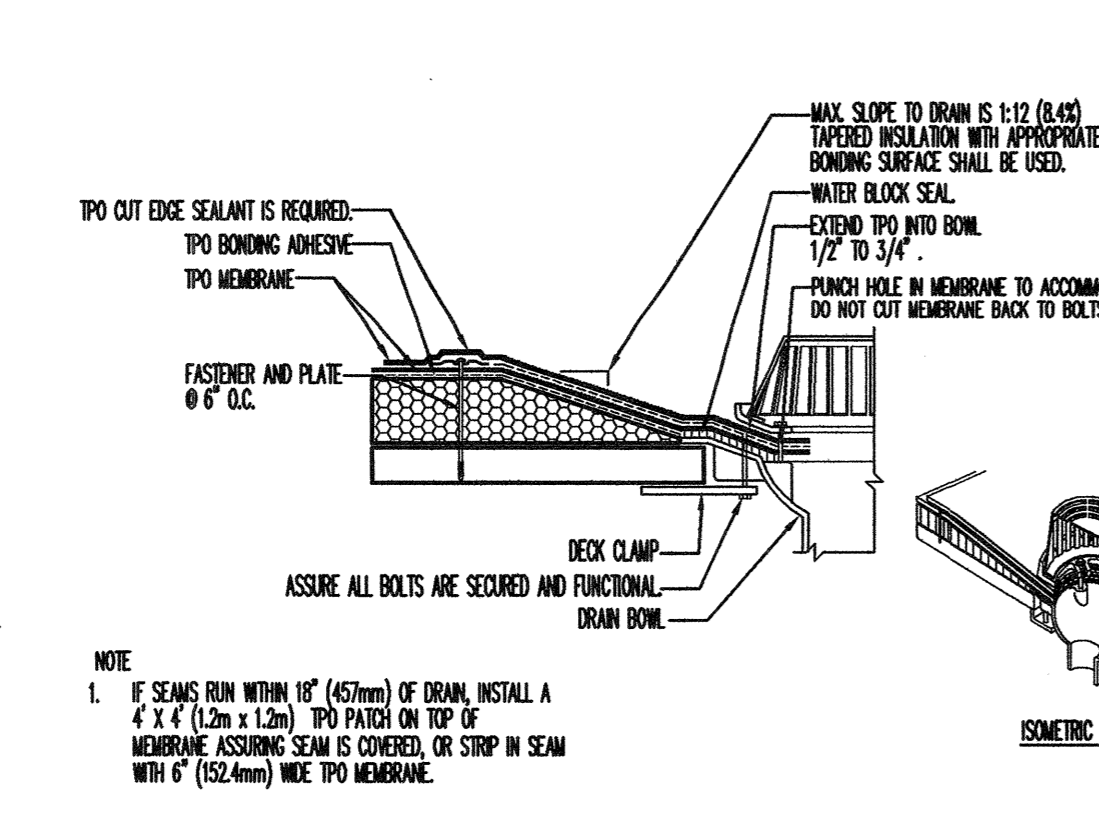


04 TPO AT ROOF DRAIN
SCALE N.T.S.

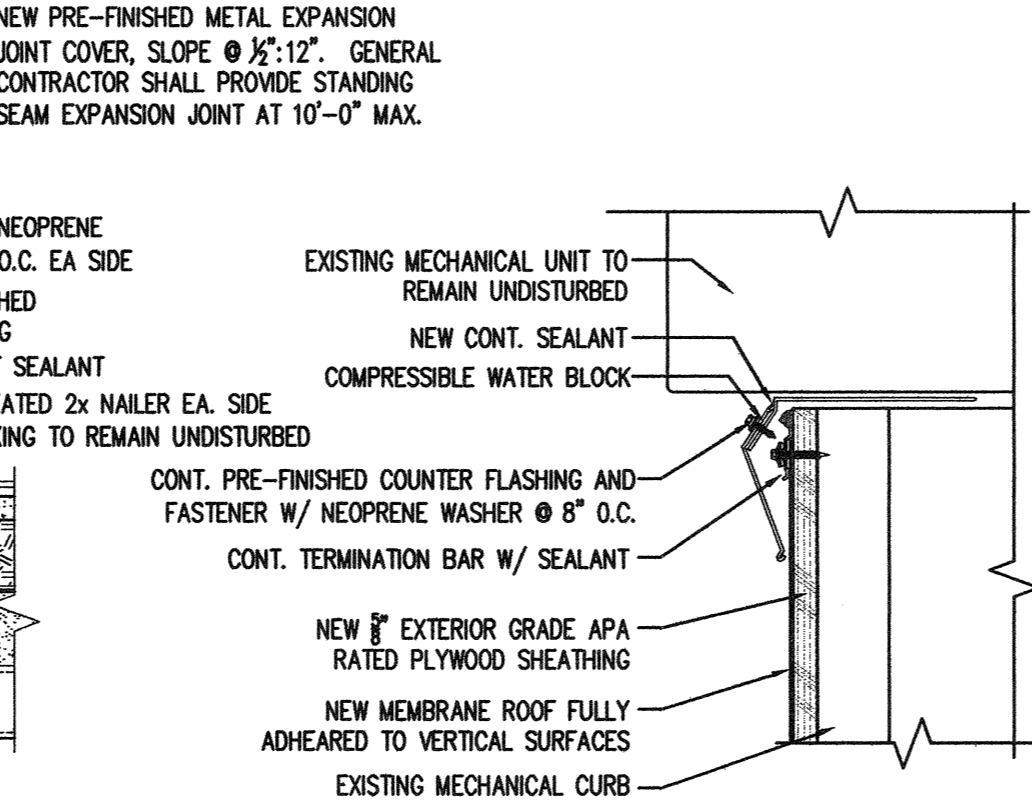


12 EXT. MECH. CURB
SCALE 3" = 1'-0"

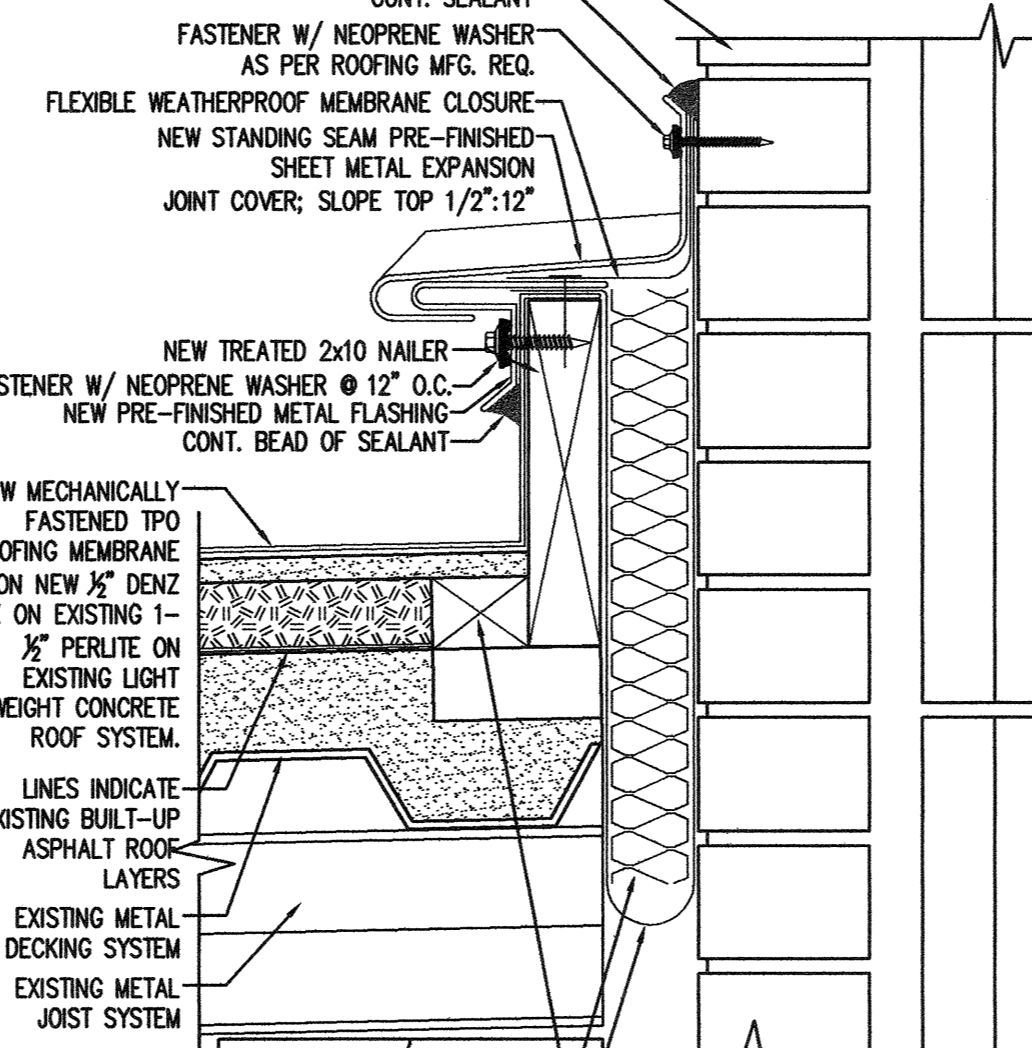


08 EXPANSION JOINT DETAIL
SCALE 3" = 1'-0"

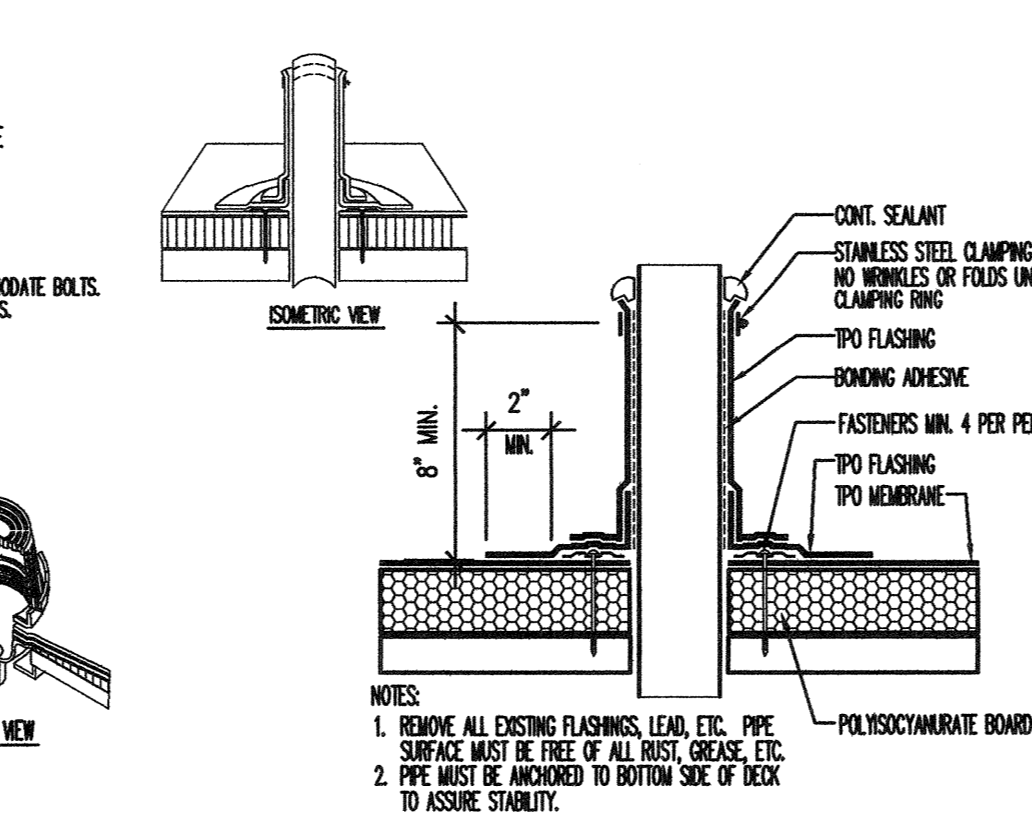


03 PIPE WRAP
SCALE N.T.S.

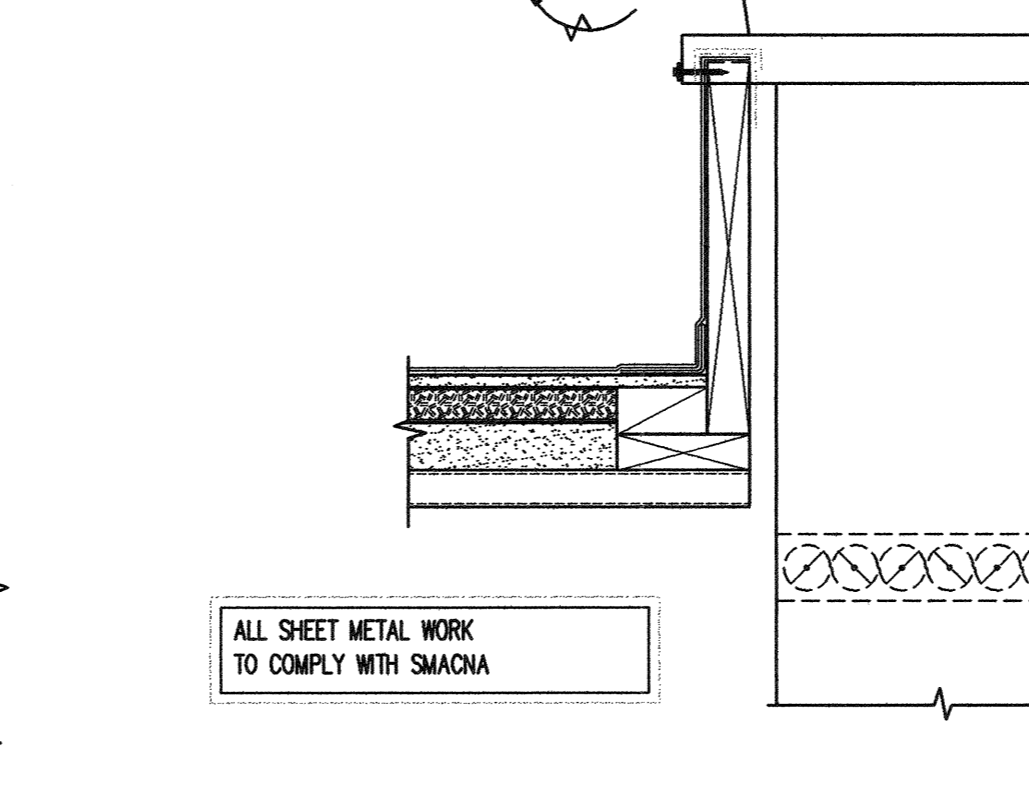


11 NEW EXHAUST HOOD AND FAN CURB DETAILS
SCALE N.T.S.

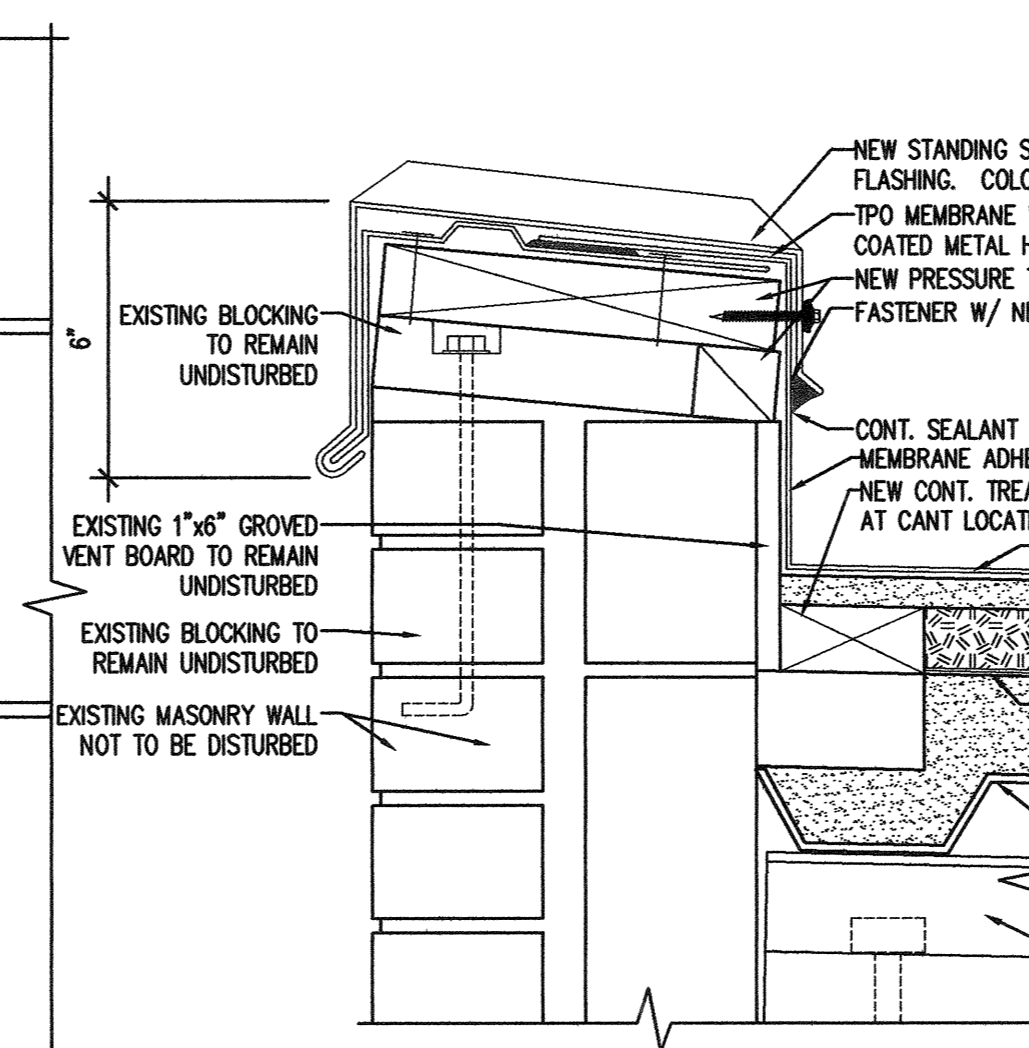


07 PARAPET DETAIL
SCALE 3" = 1'-0"

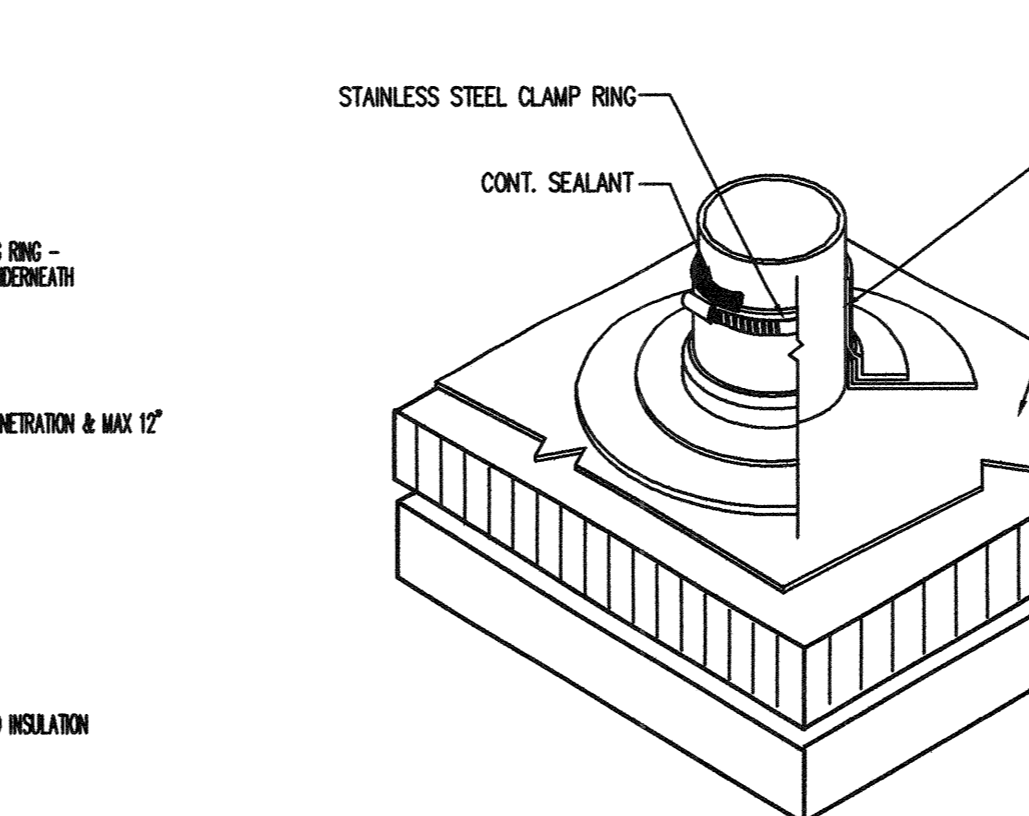


02 PIPE WRAP
SCALE N.T.S.

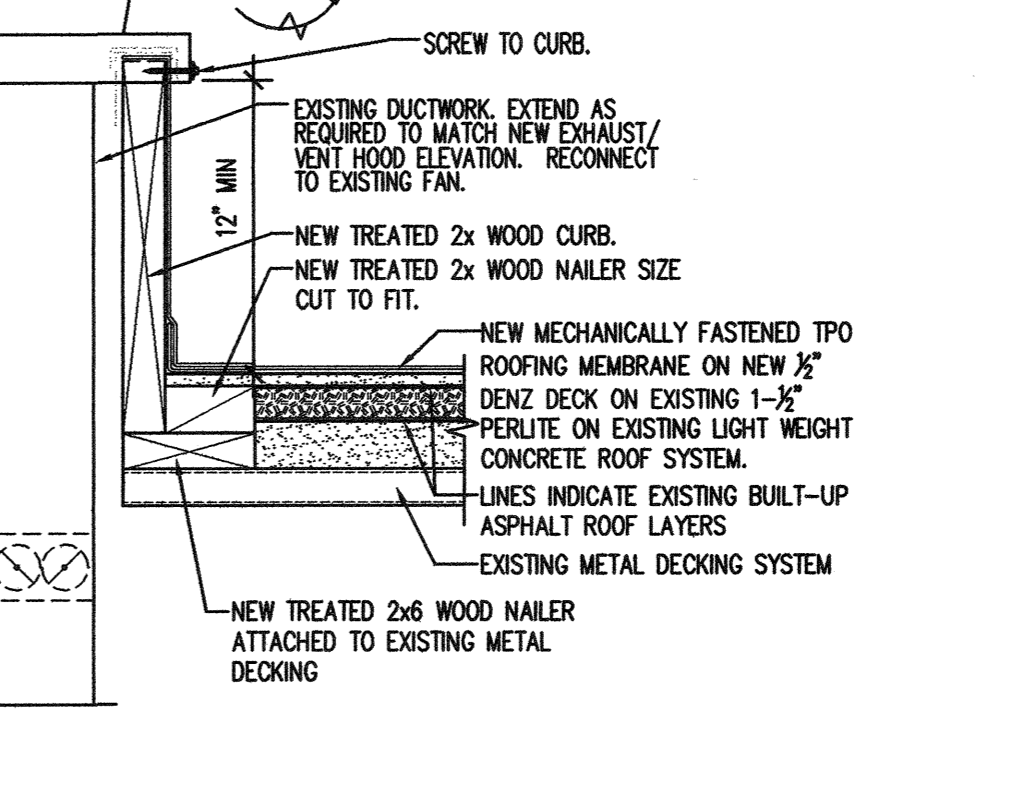

06 CURB DETAIL
SCALE N.T.S.

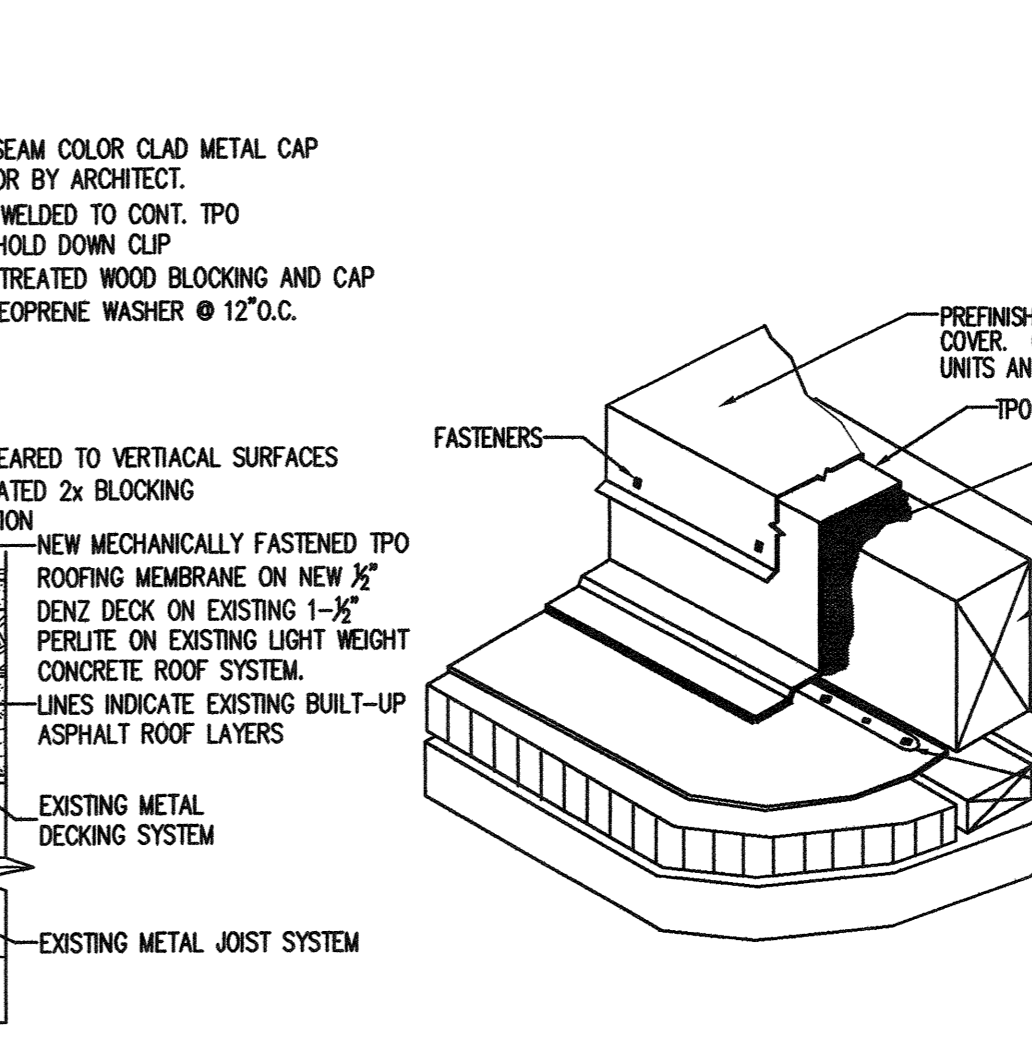

01 WALKWAY PAD
SCALE N.T.S.

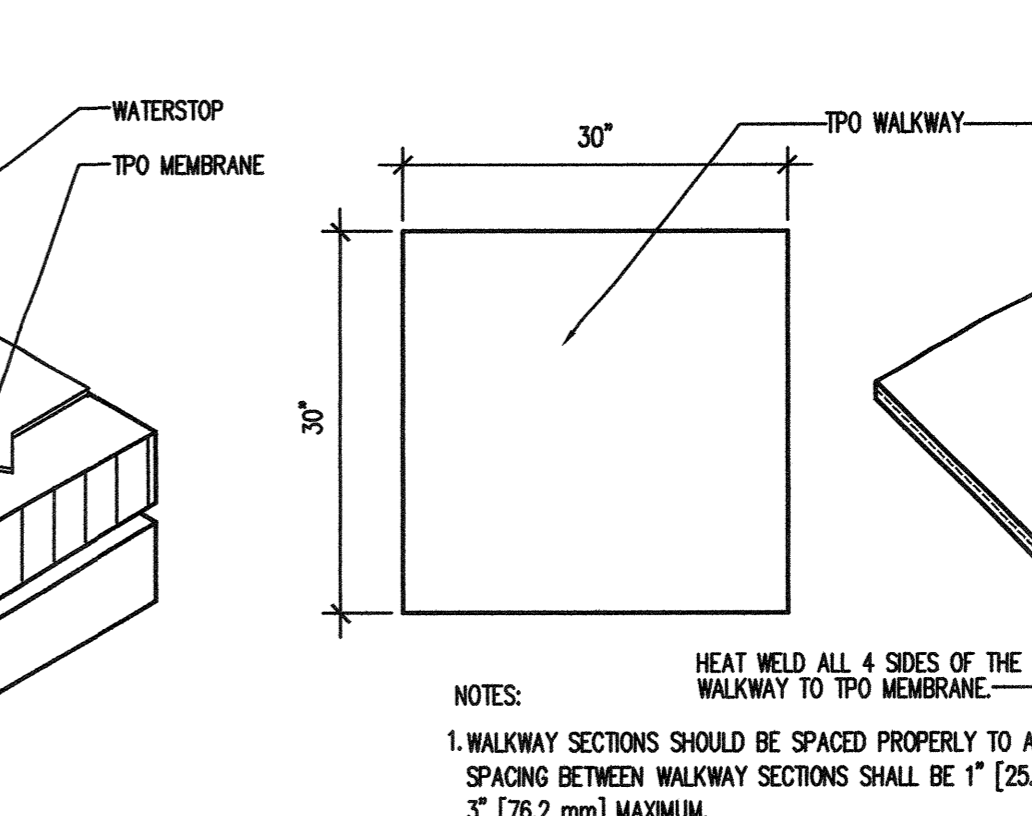

01 WALKWAY PAD
SCALE N.T.S.

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architecture planning design

BUILDING NAME:

SALT LAKE COMMUNITY COLLEGE

4600 SOUTH REDWOOD ROAD
TAYLORSVILLE, UTAH

ADMINISTRATION BUILDING

PROJECT TITLE:

SALT LAKE COMMUNITY COLLEGE
REDWOOD ROAD CAMPUS
ADMINISTRATION BUILDING
ROOFING IMPROVEMENTS

MARK DATE DESCRIPTION

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SHEET TITLE

NEW ROOF DETAILS

SHEET NUMBER

A-DT500

SHEET 8 OF 9

